

CONSTRUCTION DOCUMENT REVIEW SET  
SUBMITTED FOR PERMITTING & PRICING.

GENERAL NOTES

USE GROUP R-5  
CONSTRUCTION TYPE 5B

ALL CONSTRUCTION TO BE IN ACCORDANCE WITH THE  
INTERNATIONAL RESIDENTIAL BUILDING CODE NEW  
JERSEY EDITION 2006.

ISSUE		
NO.	DATE	REMARKS
1.	5.7.10	PERMIT SET / BID SET

SHEET INDEX

- COVER SHEET
- SITE
- SP1.1 SITE PLAN
- ARCHITECTURAL
- A1.1 MAIN LEVEL FLOOR PLAN  
A1.2 UPPER LEVEL FLOOR PLAN  
A1.3 BASEMENT AND ROOF PLANS / DETAILS  
A2.1 EAST & WEST ELEVATIONS  
A2.2 NORTH, SOUTH, & COURTYARD ELEVATIONS  
A3.1 TRANSVERSE BUILDING SECTIONS  
A3.2 LONGITUDINAL BUILDING SECTIONS
- ELECTRICAL
- E1.1 ELECTRICAL PLAN BASEMENT LEVEL  
E1.2 ELECTRICAL PLAN MAIN LEVEL  
E1.3 ELECTRICAL PLAN UPPER LEVEL

SYMBOLS KEY	
WORK POINT	
BUILDING SECTION MARKER	
DETAIL SECTION MARKER	
DETAIL MARKER	
BUILDING ELEVATION MARKER	
INTERIOR ELEVATION MARKER	
NORTH ARROW	


I PERSONALLY PREPARED THE PLANS SUBMITTED FOR THIS  
SINGLE FAMILY DWELLING TO BE OWNED AND OCCUPIED BY  
MYSELF.

OWNER SIGNATURE: \_\_\_\_\_

MOORESTOWN  
RESIDENCE

WILLIAMS AVENUE, MOORSETOWN, NEW JERSEY

PROJECT TITLE:		
COVER SHEET		
SHEET TITLE:		
AS NOTED	JES	CS
SCALE:	DRAWN BY:	
4.28.10	JES	
DATE:	CHECKED BY:	
FILE:	SHEET NUMBER:	

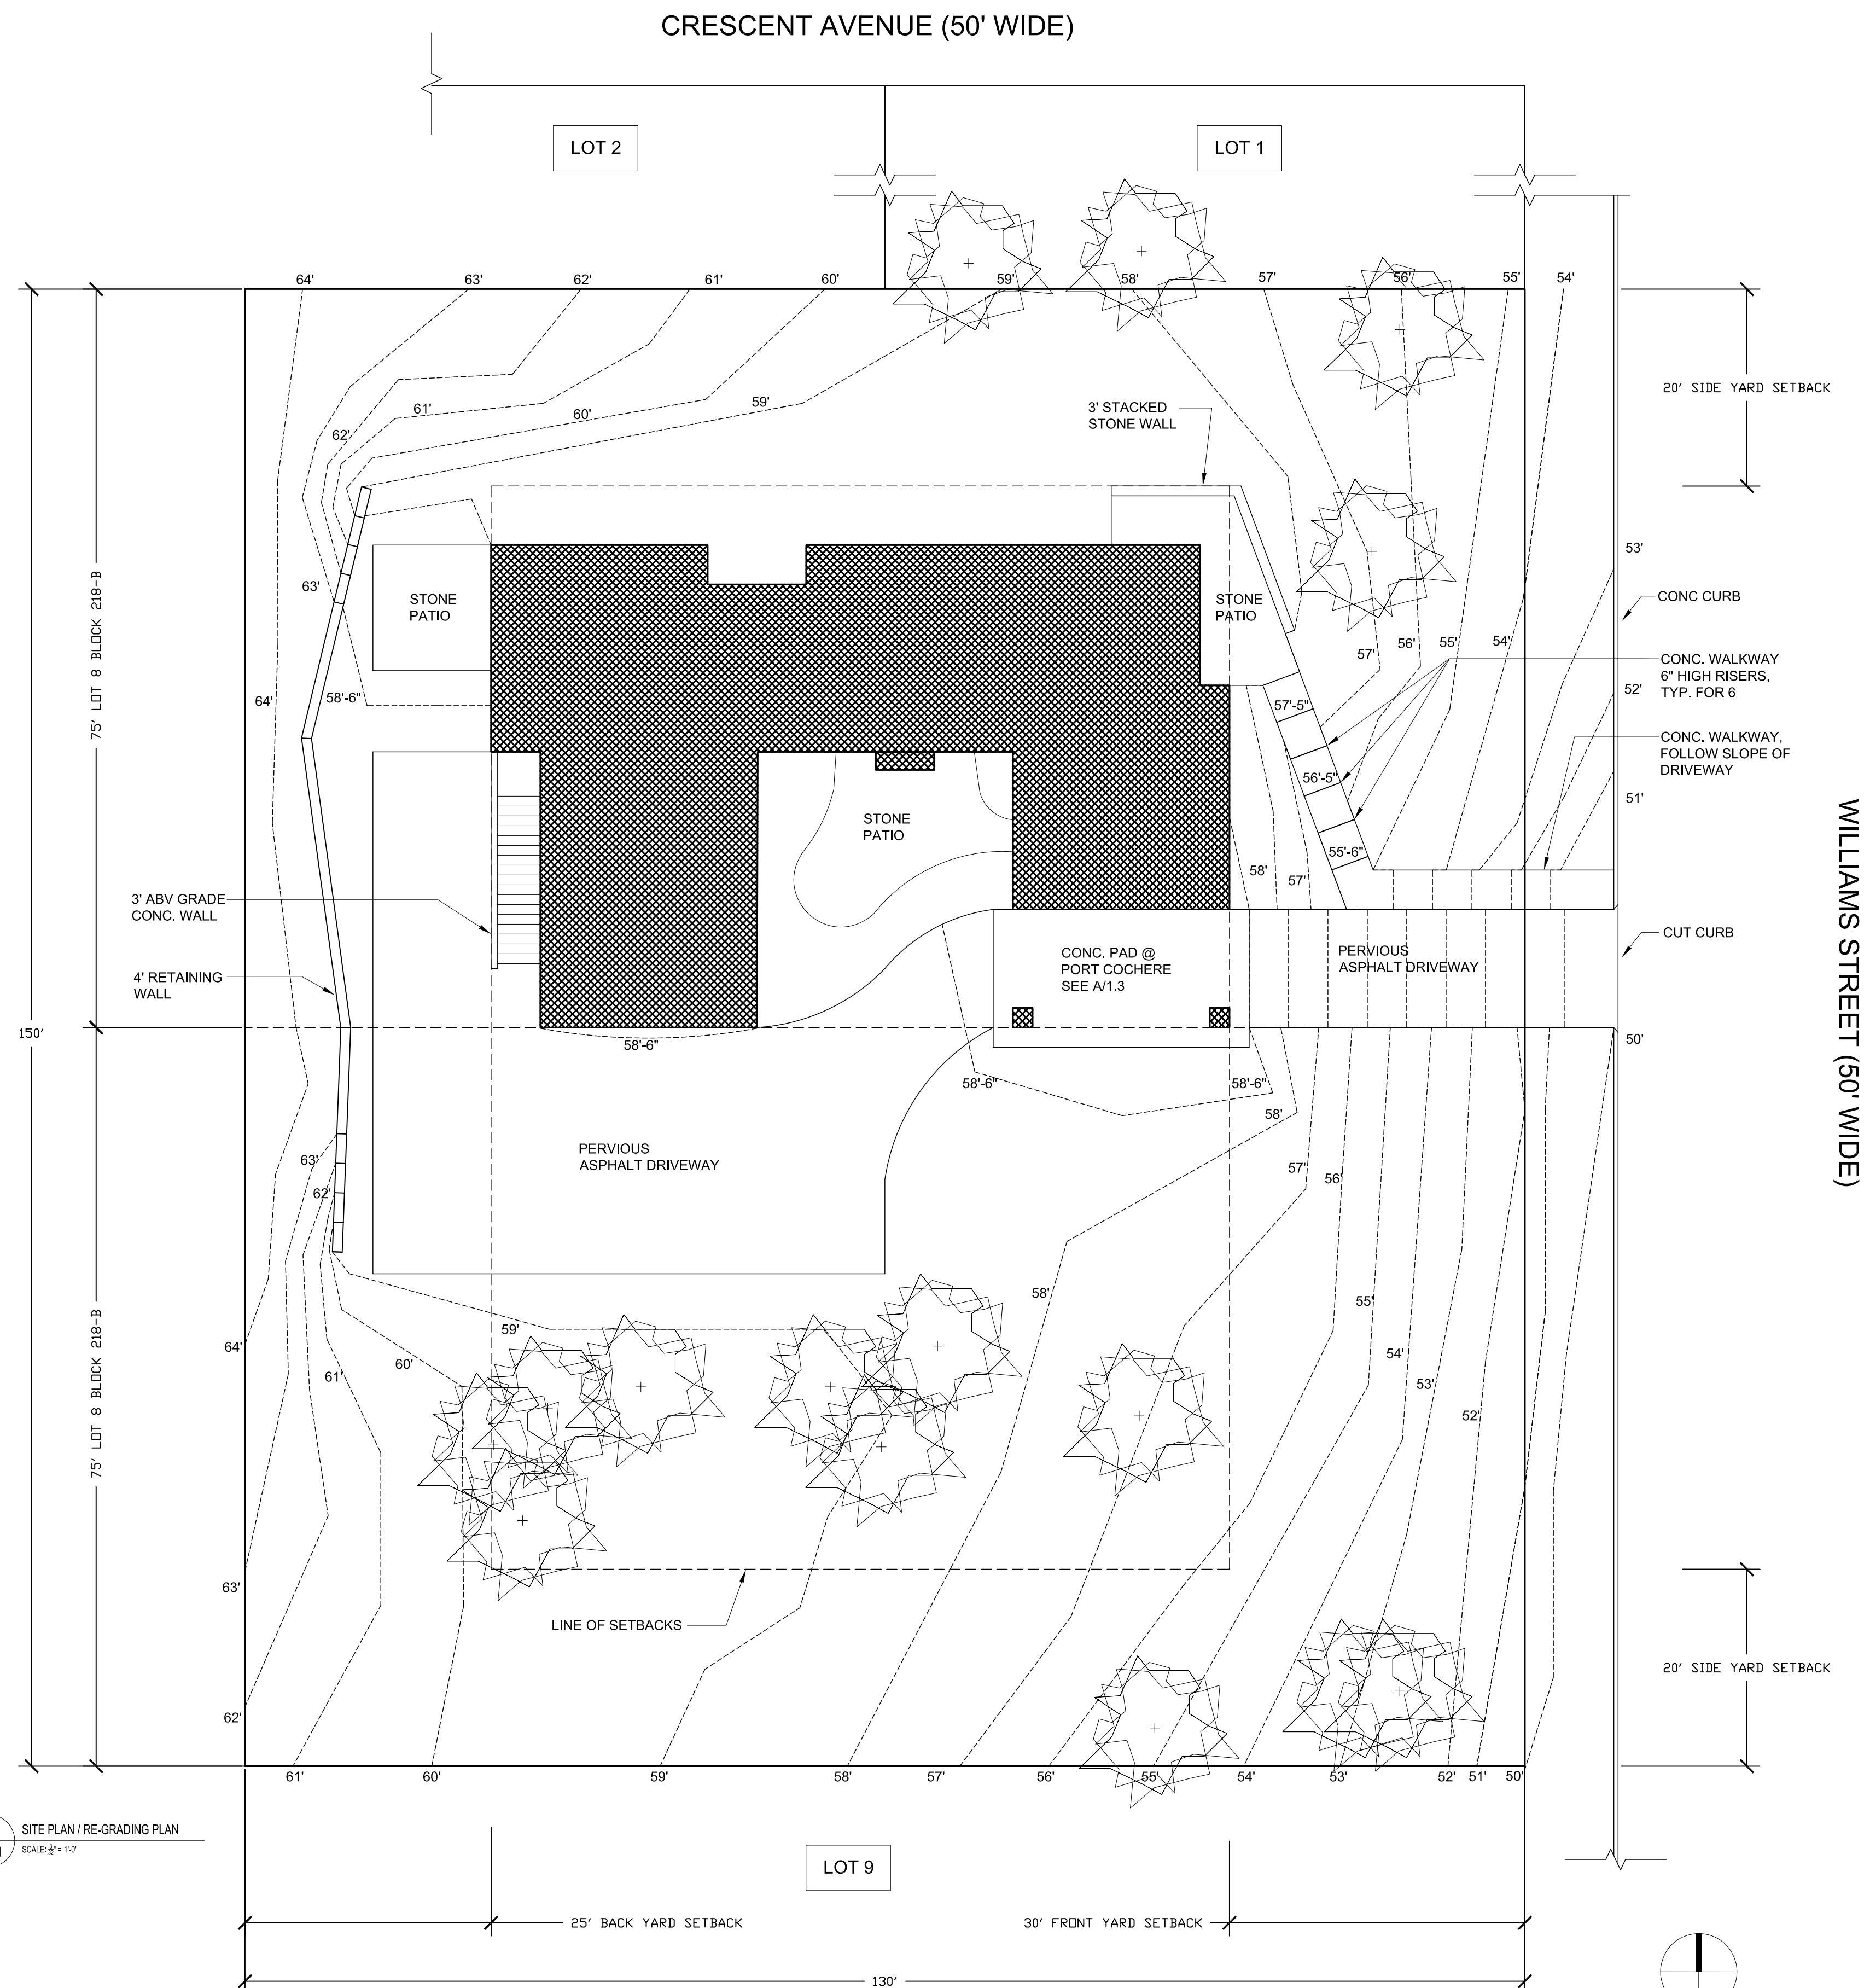

- GENERAL NOTES**
1. LEVEL GRADE (ELEV. 58'-0") @ BUILDING FOOTPRINT, TYP. PROVIDE ADDITIONAL FILL/SOIL AS REQ'D TO ACHIEVE GRADE.
  2. GRADE TO BE 58'-6" @ PORT COCHERE ENTRANCE, REAR PATIO SLIDER, AND GARAGE ENTRANCE. ALIGN EXTERIOR THRESHOLD W/ SUBFLOOR THESE LOCATIONS.
  3. EXISTING GRADE TO BE VERIFIED IN FIELD. RE-GRADING HAS BEEN DEVELOPED PER SURVEY DRAWINGS LL-10-27674 & LL-10-27675 (SUBMITTED WITH CONSTRUCTION DOCUMENT SET). IF CONFLICTS WITH SURVEY DRAWINGS AND EXISTING TOPOGRAPHY OF SITE EXIST, CONTRACTOR MUST NOTIFY OWNER BEFORE PROCEEDING WITH SITE WORK.
  4. TREE REMOVAL TO BE VERIFIED IN FIELD WITH OWNER PRIOR TO SITE WORK.
  5. REFER TO A/1.3 FOR STRUCTURAL NOTES AND DETAILS.

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DETAIL SECTION MARKER	
DETAIL MARKER	
BUILDING ELEVATION MARKER	
INTERIOR ELEVATION MARKER	
NORTH ARROW	

I PERSONALLY PREPARED THE PLANS SUBMITTED FOR THIS SINGLE FAMILY DWELLING TO BE OWNED AND OCCUPIED BY MYSELF.

OWNER SIGNATURE: \_\_\_\_\_

**MOORESTOWN RESIDENCE**  
WILLIAMS AVENUE, MOORESTOWN, NEW JERSEY

PROJECT TITLE:

**SITE PLAN**

AS NOTED	JES
SCALE:	DRAWN BY:
4.28.10	JES
DATE:	CHECKED BY:
FILE:	SHEET NUMBER:

**SP1.1**

CONSTRUCTION DOCUMENT REVIEW SET  
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GENERAL NOTES

1. EXTERIOR WALLS SHOWN @ 8" NOMINAL THICKNESS FOR 8.25" SIP LAYOUT, TYP.

2. INTERIOR PARTITIONS SHOWN @ 3.5" NOMINAL THICKNESS FOR FRAMING LAYOUT, TYP. PARTITIONS W/ POCKET DOORS SHOWN 8" THICK.

ISSUE		
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SYMBOLS KEY	
WORK POINT	
BUILDING SECTION MARKER	
DETAIL SECTION MARKER	
DETAIL MARKER	
BUILDING ELEVATION MARKER	
INTERIOR ELEVATION MARKER	
NORTH ARROW	

I PERSONALLY PREPARED THE PLANS SUBMITTED FOR THIS SINGLE FAMILY DWELLING TO BE OWNED AND OCCUPIED BY MYSELF.

OWNER SIGNATURE: \_\_\_\_\_

**MOORESTOWN  
RESIDENCE**  
WILLIAMS AVENUE, MOORSETOWN, NEW JERSEY


PROJECT TITLE:

UPPER LEVEL FLOOR PLAN

SHEET TITLE:	
AS NOTED	JES/MH
SCALE:	DRAWN BY:
4.28.10	JES
DATE:	CHECKED BY:
FILE:	SHEET NUMBER:

A1.2

CONSTRUCTION DOCUMENT REVIEW SET  
SUBMITTED FOR PERMITTING & PRICING.

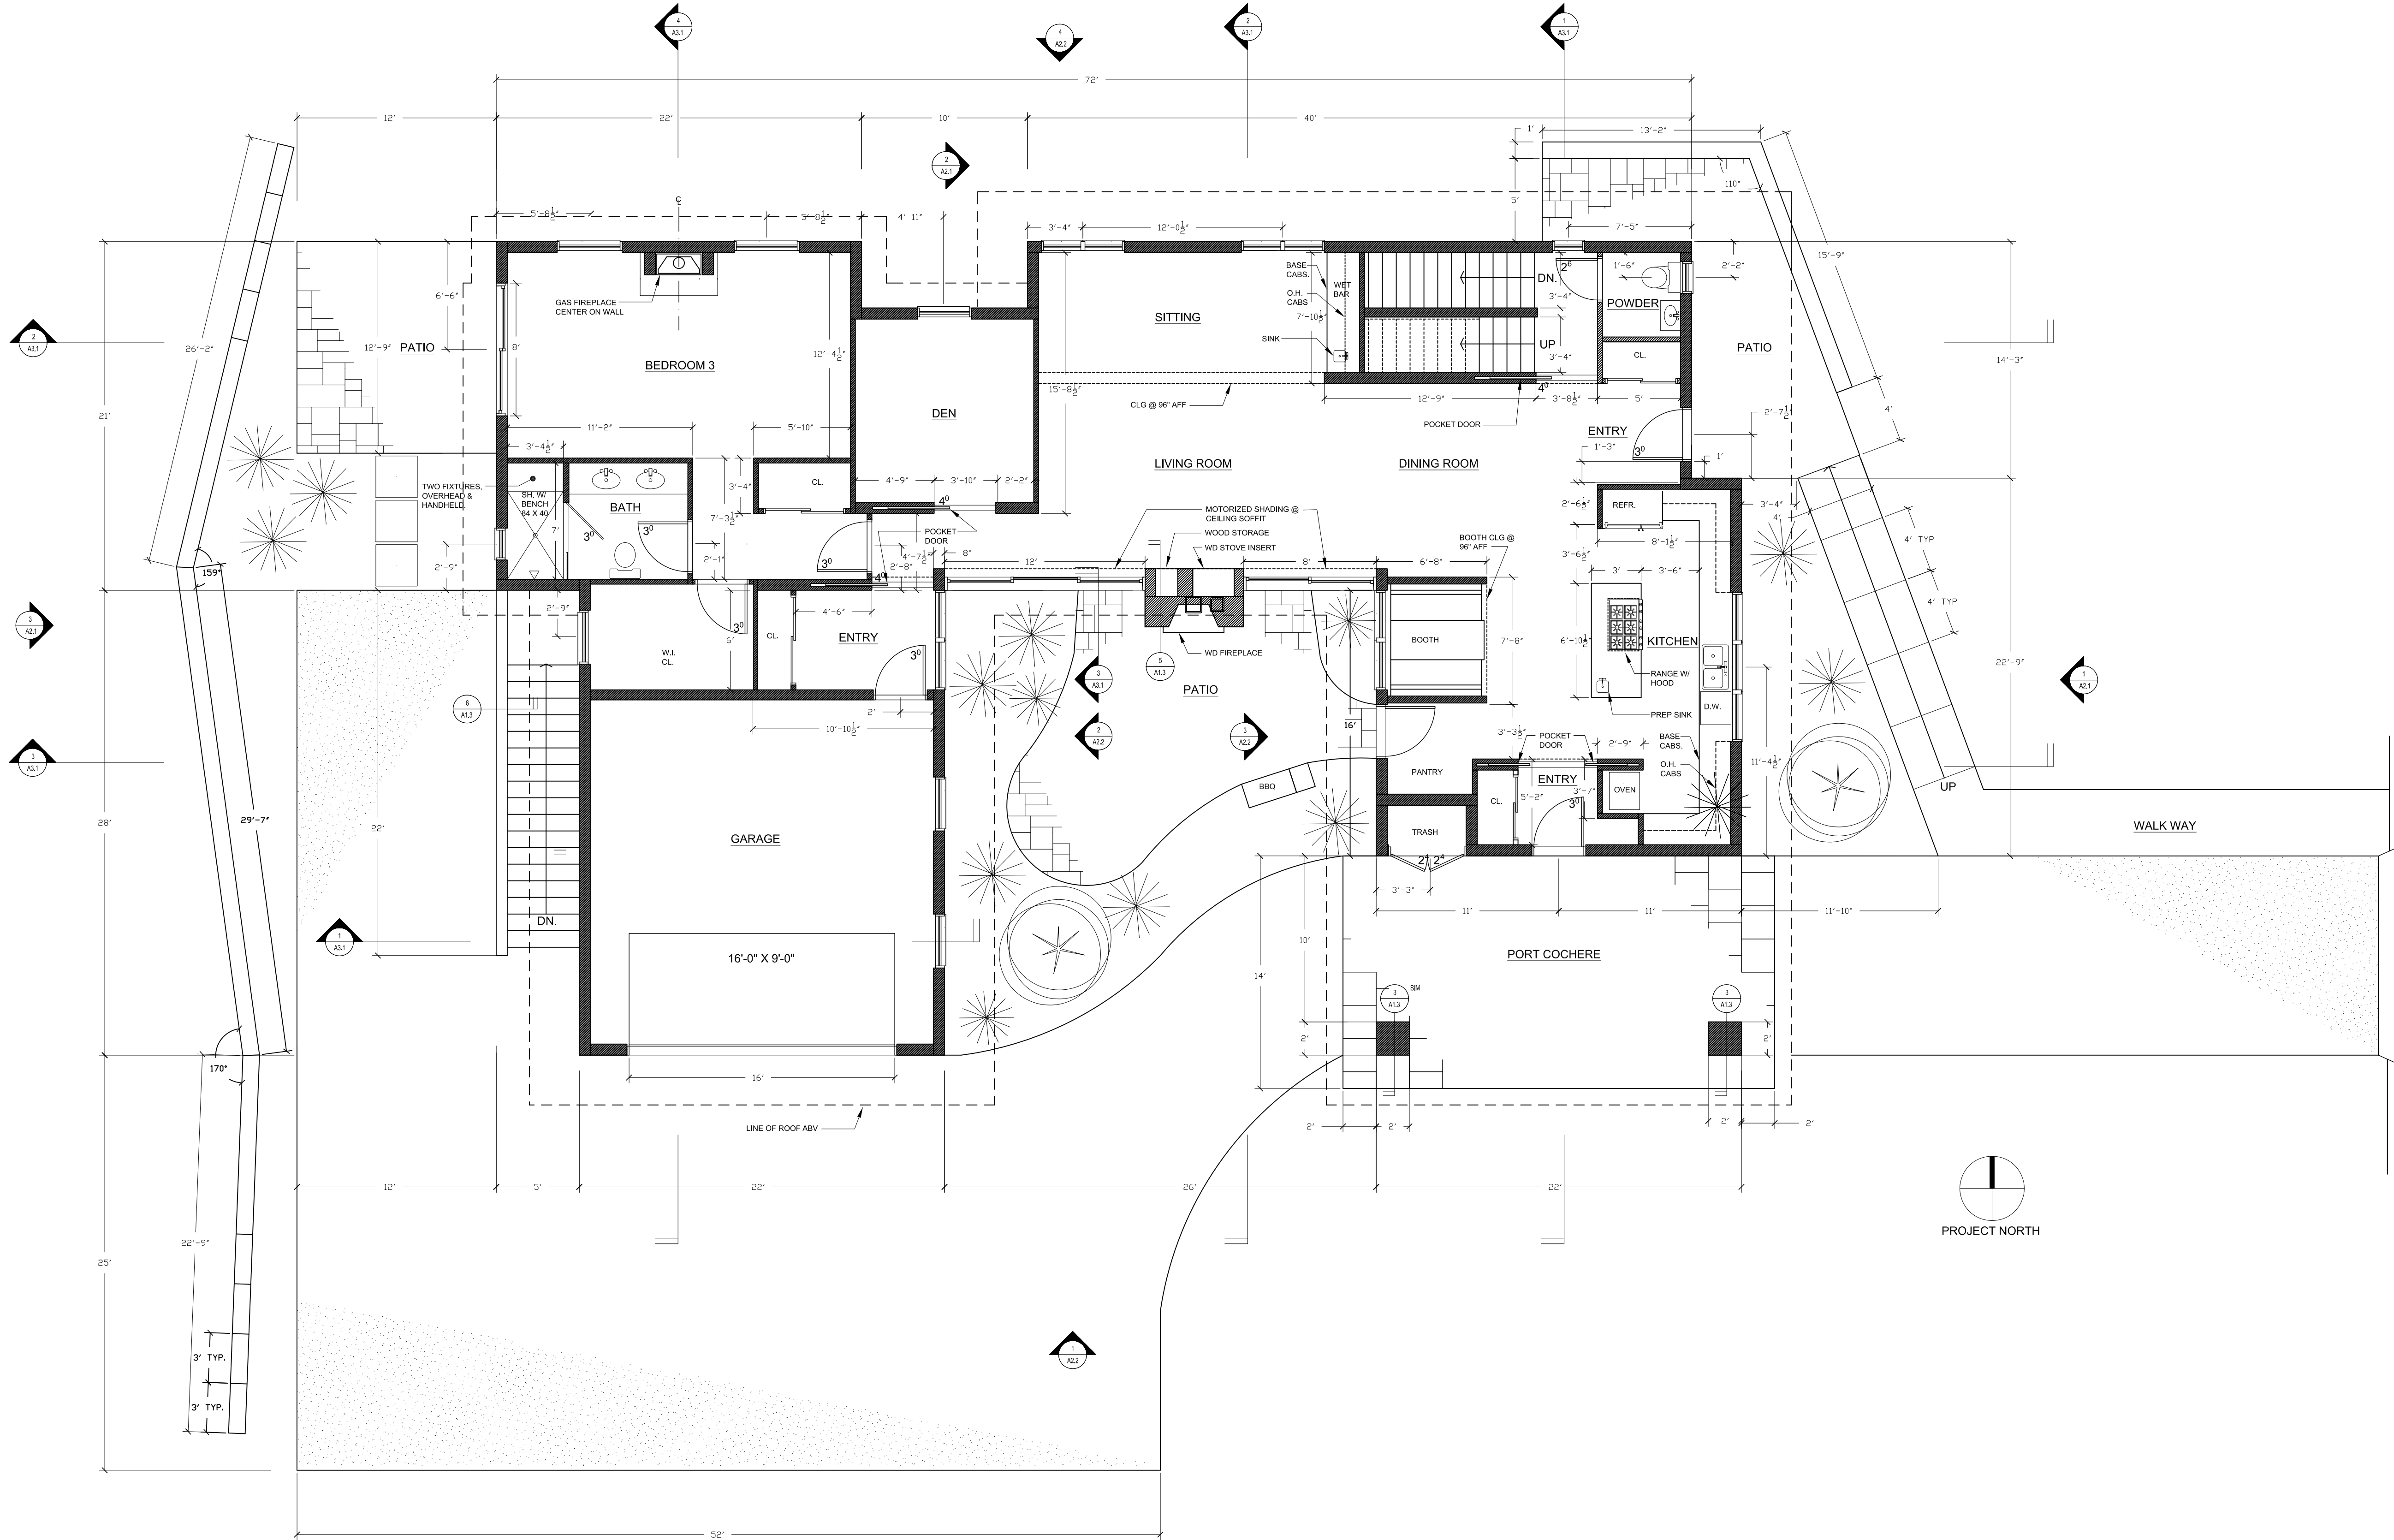

1 MAIN LEVEL FLOOR PLAN  
A1.1 SCALE: 3/8" = 1'-0"

- GENERAL NOTES**
- EXTERIOR WALLS SHOWN @ 8" NOMINAL THICKNESS FOR 8.25" SIP LAYOUT, TYP.
  - INTERIOR PARTITIONS SHOWN @ 3.5" NOMINAL THICKNESS FOR FRAMING LAYOUT, TYP. PARTITIONS W/ POCKET DOORS SHOWN 8" THICK.

ISSUE		
NO.	DATE	REMARKS
1.	5.7.10	PERMIT SET / BID SET

SYMBOLS KEY	
WORK POINT	
BUILDING SECTION MARKER	
DETAIL SECTION MARKER	
DETAIL MARKER	
BUILDING ELEVATION MARKER	
INTERIOR ELEVATION MARKER	
NORTH ARROW	

I PERSONALLY PREPARED THE PLANS SUBMITTED FOR THIS SINGLE FAMILY DWELLING TO BE OWNED AND OCCUPIED BY MYSELF.

OWNER SIGNATURE: \_\_\_\_\_

**MOORESTOWN  
RESIDENCE**  
WILLIAMS AVENUE, MOORSETOWN, NEW JERSEY

PROJECT TITLE:


MAIN LEVEL FLOOR PLAN

SHEET TITLE:	
AS NOTED	JES/MH
SCALE:	DRAWN BY:
4.28.10	JES
DATE:	CHECKED BY:
FILE:	SHEET NUMBER:

A1.1

CONSTRUCTION DOCUMENT REVIEW SET  
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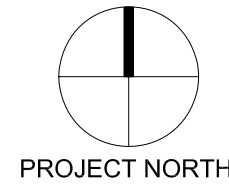


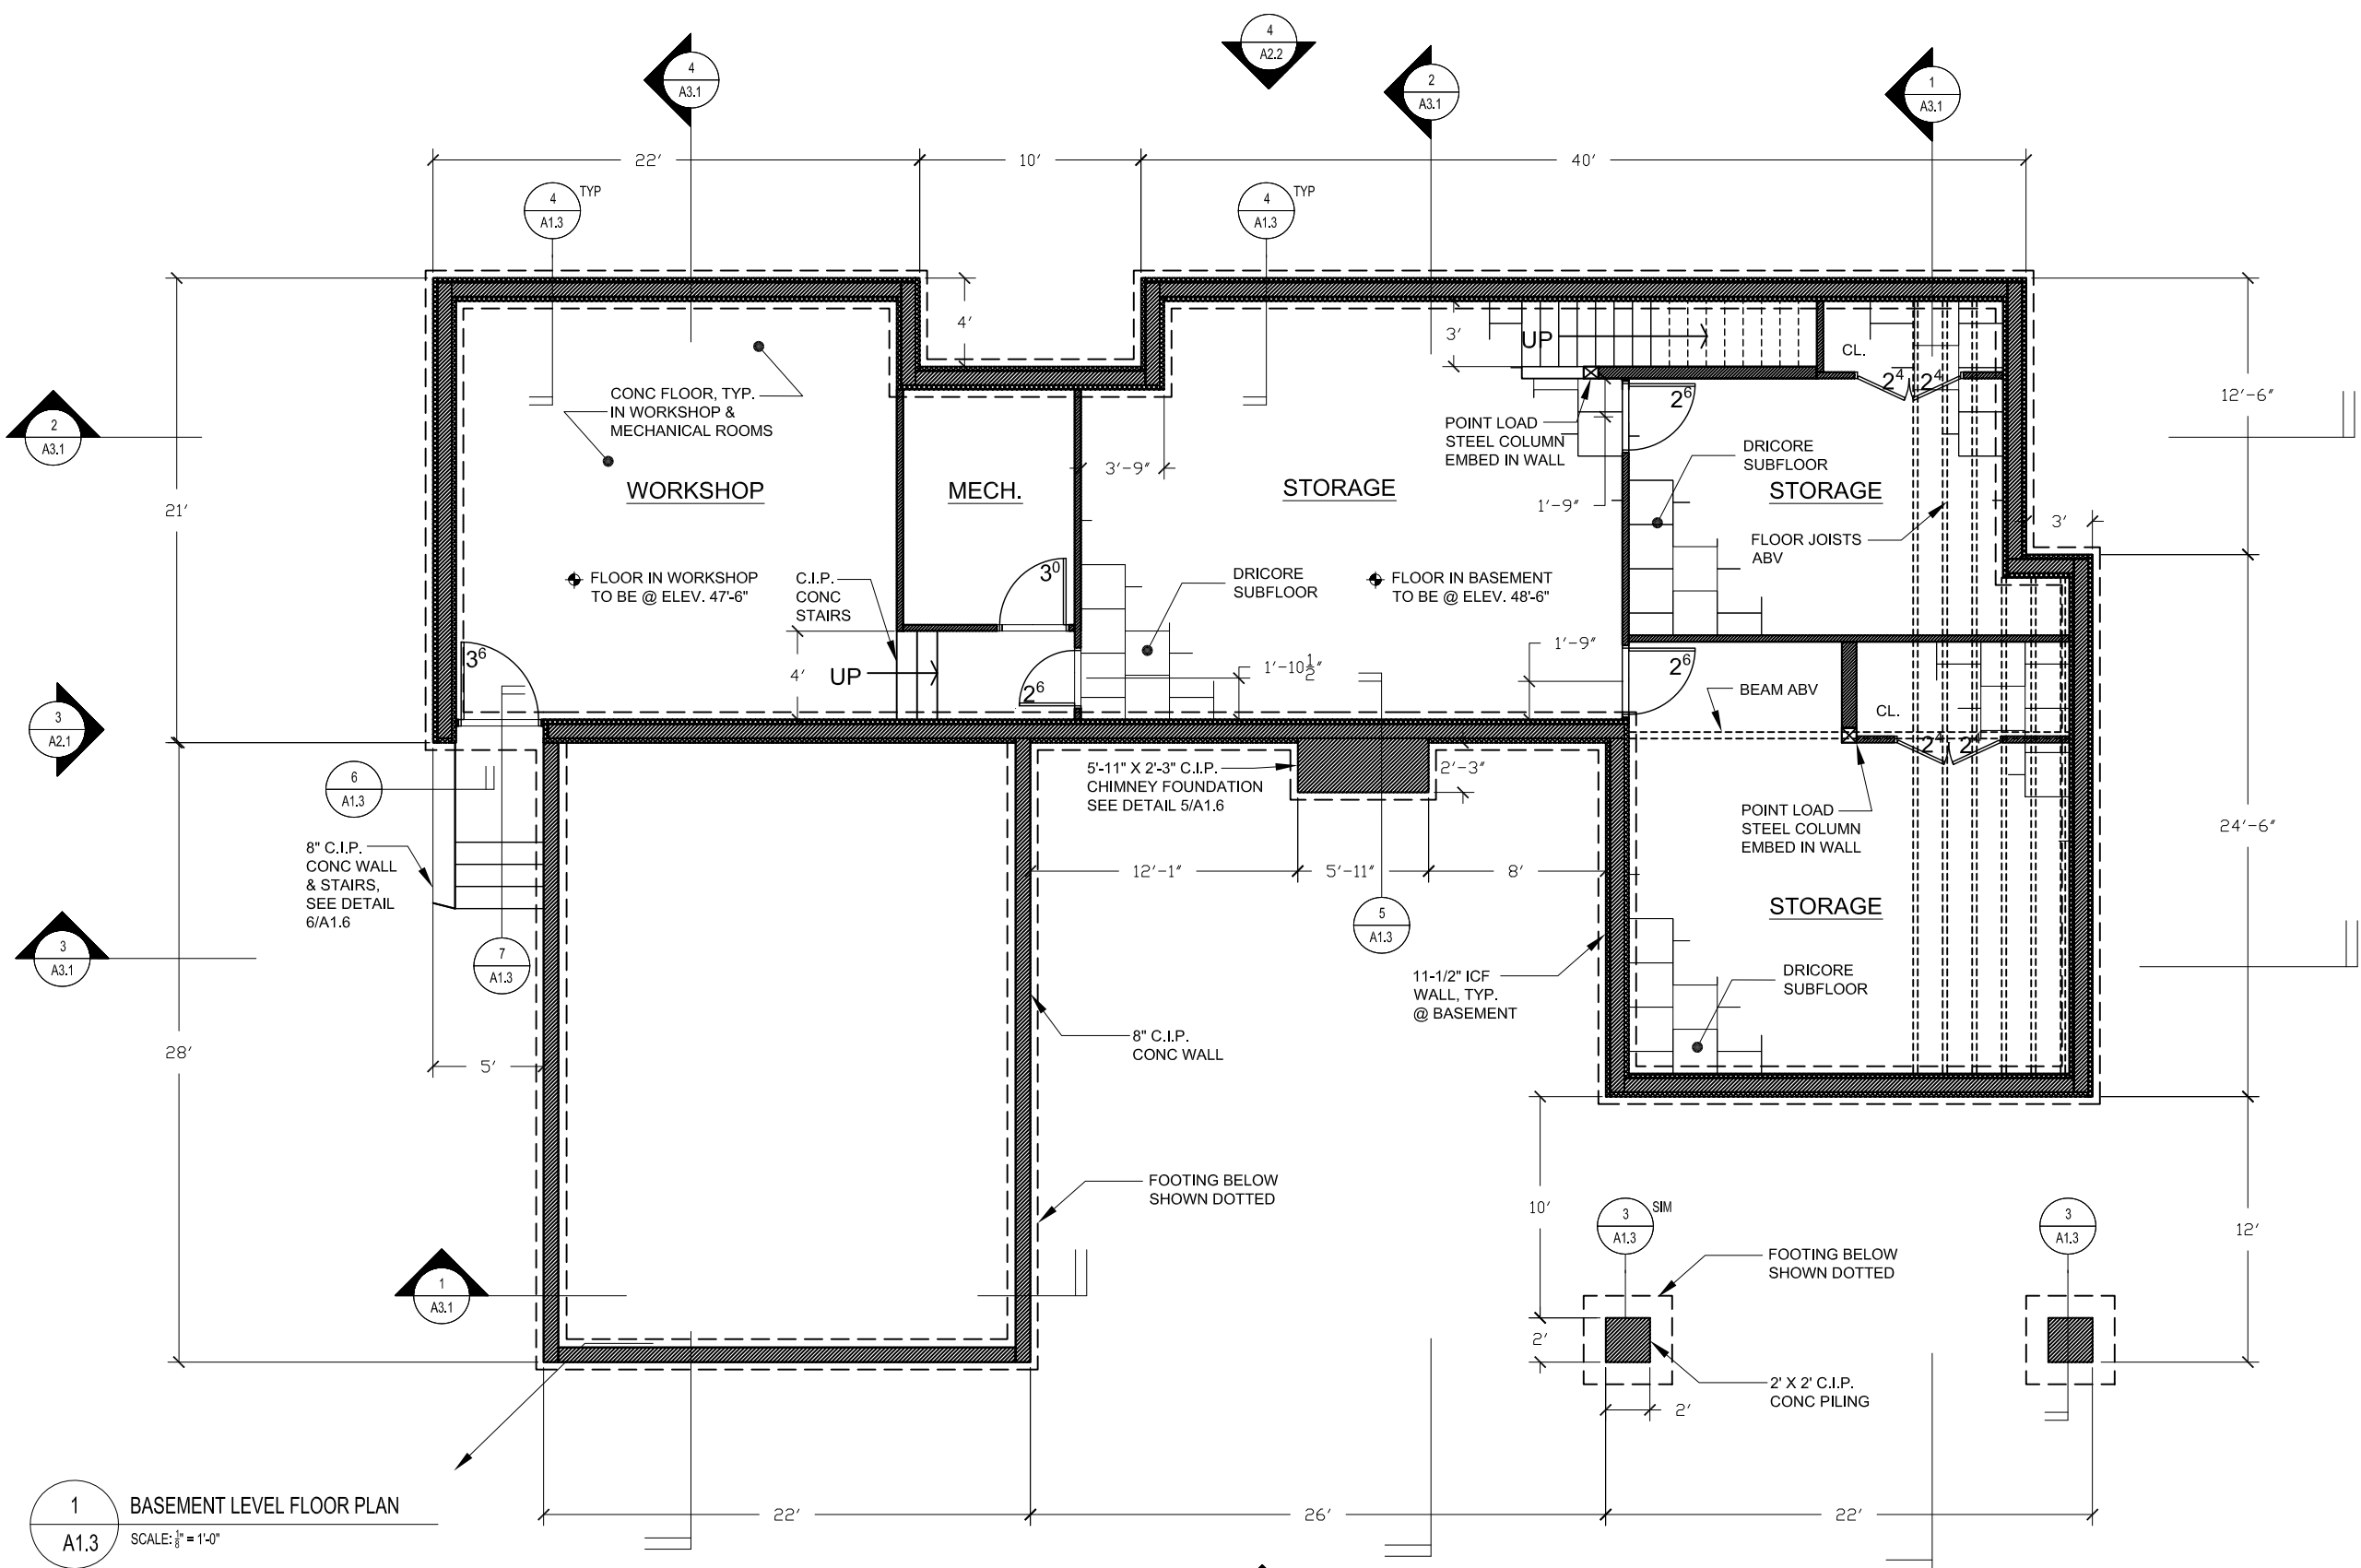


1 BASEMENT LEVEL FLOOR PLAN  
SCALE: 1/4" = 1'-0"

B.O.F.  
BELOW FROST, TYP.

SUBFLOOR (FLOOR 1)  
ELEV. 58'-6"



T.O.S.  
@ WORKSHOP  
ELEV. 47'-6"

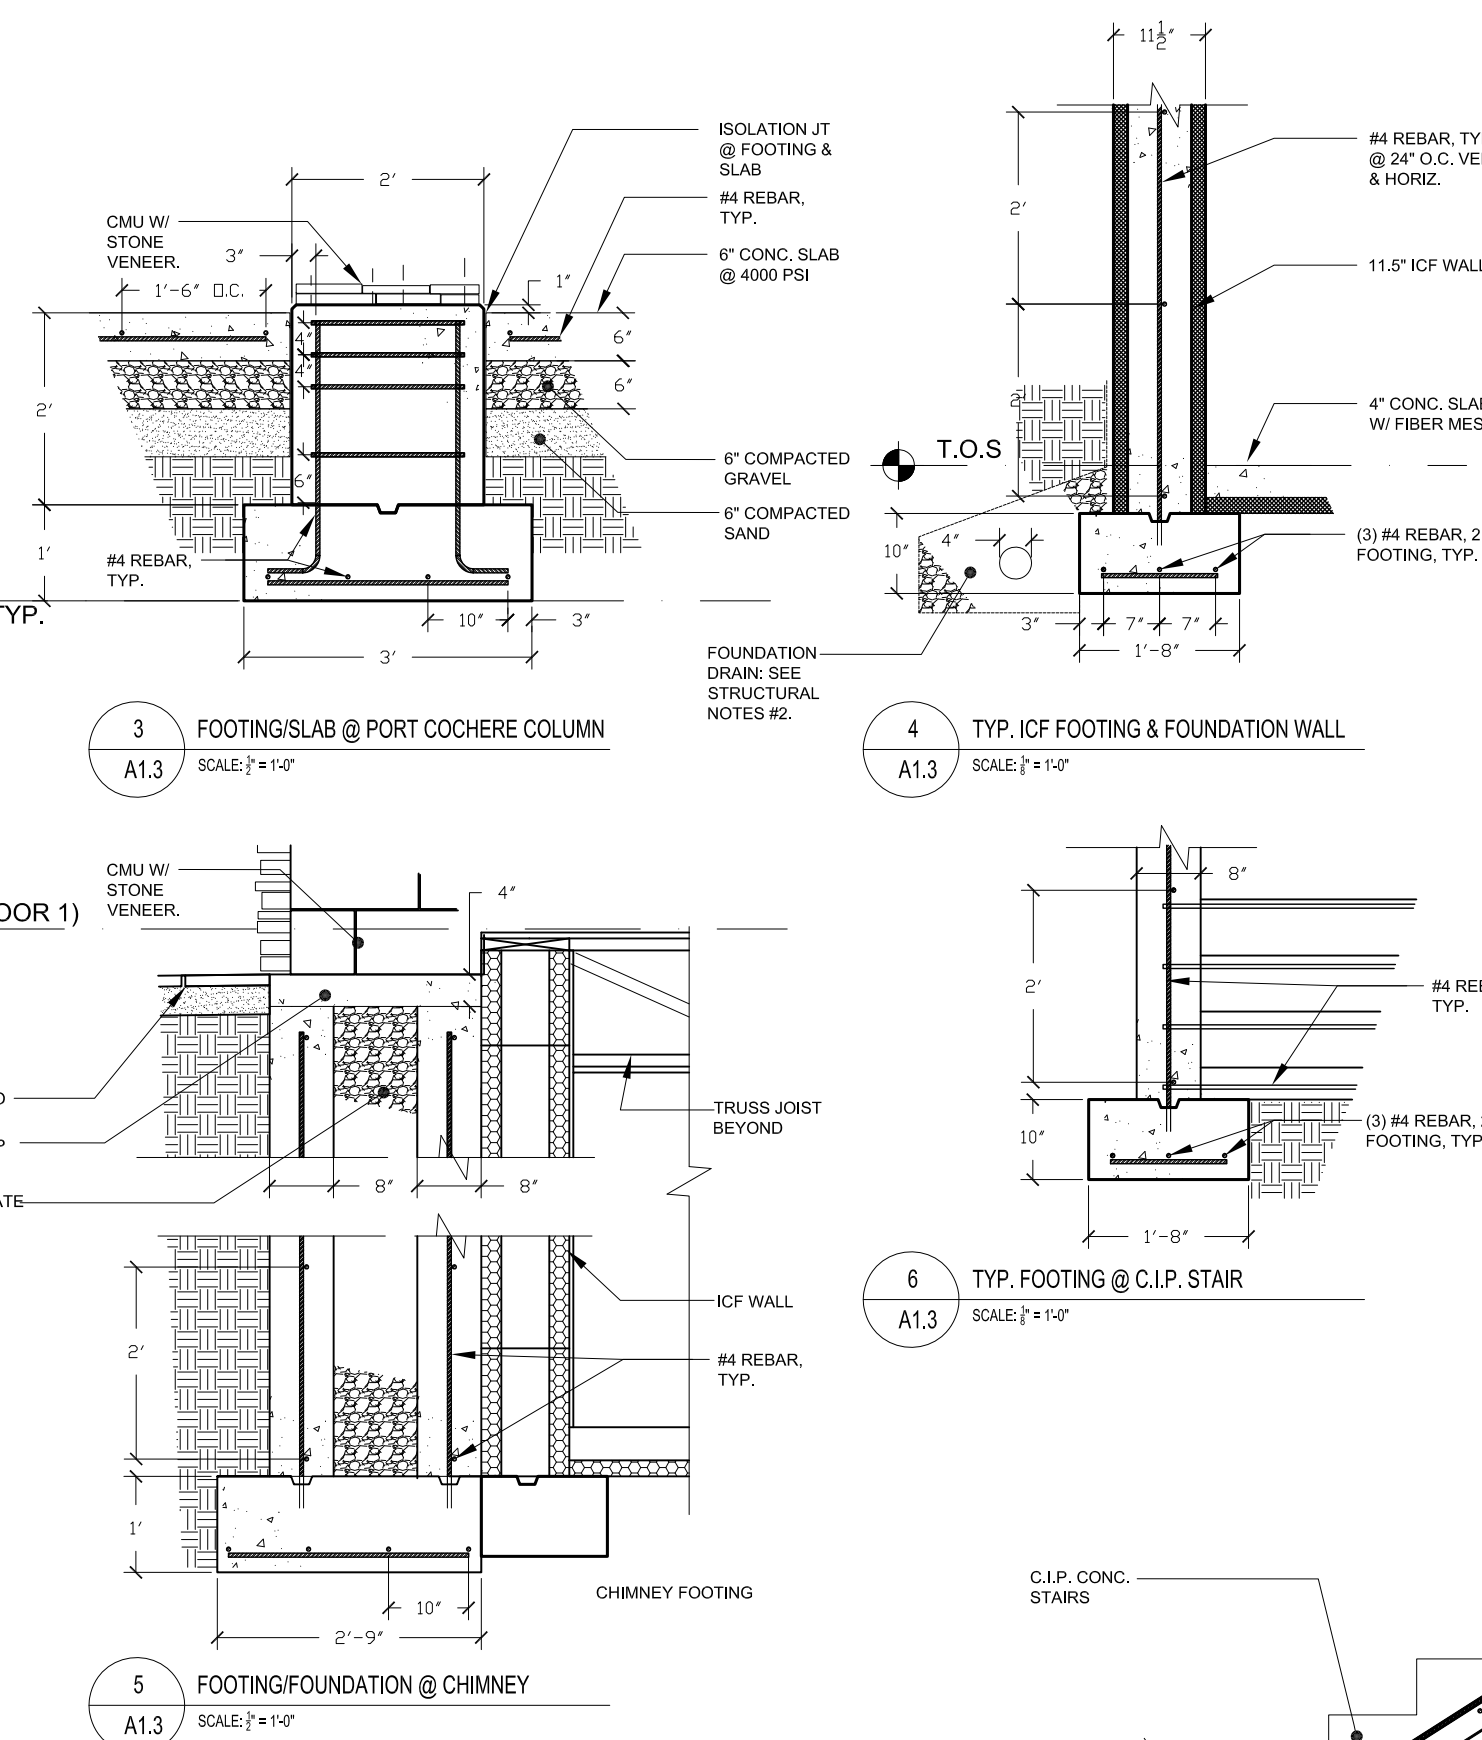

3 FOOTING/SLAB @ PORT COCHERE COLUMN  
SCALE: 1/2" = 1'-0"

5 FOOTING/FOUNDATION @ CHIMNEY  
SCALE: 1/2" = 1'-0"

6 TYP. FOOTING @ C.I.P. STAIR  
SCALE: 1/2" = 1'-0"

7 SECTION @ CONCRETE STAIR  
SCALE: 1/2" = 1'-0"

## STRUCTURAL NOTES

(3000PSI CONCRETE, TYP. 4000PSI CONCRETE @ PORT COCHERE)

1. BASEMENT SLAB: SLAB TO BE 4" THICK FIBER-MESH CONCRETE OVER 2" XPS INSULATION, SEAMS TAPED W/ CONSTRUCTION SEAMING TAPE, TYP. CONTRACTOR TO CONFIRM SLAB SPECIFICATIONS PER LOCAL CODE REQUIREMENTS.

2. FOOTINGS: FOOTINGS TO BE 10" DEEP X 1'-8" WIDE, TYP. @ FOUNDATION WALLS. PROVIDE (3) #4 REBAR HORIZONTAL @ 6" O.C. FROM CL OF FOOTING, TYP. CONTRACTOR TO CONFIRM FOOTING SIZE AND REBAR PER LOCAL CODE REQUIREMENTS. PROVIDE FOUNDATION DRAIN @ BASEMENT FOUNDATION WALL, TYP. 4" DIA. PERFORATED PVC PIPE WITH 3/4" DIA. CRUSHED STONE IN FILTER WRAP, MIN. 6" STONE COVERAGE ALL AROUND PIPE.

3. ICF WALLS: PROVIDE #4 REBAR @ 24" O.C. VERTICALLY AND HORIZONTALLY @ ICF WALLS, TYP. EMBED REBAR IN FOOTING PER LOCAL CODE REQUIREMENTS. SEE 4/A1.3

4. PORT COCHERE SLAB: SLAB TO BE 6" THICK W/ #4 BAR EACH WAY HORIZONTAL @ 18" O.C., TYP. PROVIDE 6" COMPACTED GRAVEL ON 6" COMPACTED SAND. 4000PSI CONCRETE, TYP. THIS LOCATION. SEE 3/A1.3

5. PORT COCHERE COLUMN FOOTINGS: SEE 3/A1.3

6. CHIMNEY FOOTING & FOUNDATION: SEE 5/A1.3. PROVIDE 12" DEEP FOOTING W/ #4 REBAR 7" O.C., TYP. 8" C.I.P. CONC. PROVIDE #4 REBAR @ 24" O.C. VERTICALLY AND HORIZONTALLY, TYP. FILL W/ 2B COMPACTED AGGREGATE, CAP W/ 4" THICK CONC SLAB

7. CONC. STAIR: SEE DETAILS 6/A1.3 & 7/A1.3, 8" C.I.P. CONC. PROVIDE #4 REBAR @ 24" O.C. VERTICALLY AND HORIZONTALLY, TYP.

## GENERAL NOTES

1. BASEMENT TO BE UNFINISHED. PROVIDE DRICORE SUBFLOOR WHERE INDICATED.

2. INTERIOR PARTITIONS SHOWN @ 3.5" NOMINAL THICKNESS FOR FRAMING LAYOUT, TYP. PROVIDE ACOUSTIC INSULATION WHERE INDICATED.

3. ALL ROOVES TO BE STANDING SEAM METAL, TYP.

4. ROOVES TO HAVE 3' SOFFIT @ LOW HIPPED ROOF TYP. 1'-6" SOFFIT @ HIGH GABLE ROOVES, TYP. & 2' OVERHANG @ HIGH ROOF GABLE ENDS, TYP. FOR 4.

## ISSUE

NO.	DATE	REMARKS
1.	5.7.10	PERMIT SET / BID SET

## SYMBOLS KEY

WORK POINT

BUILDING SECTION MARKER

DETAIL SECTION MARKER

DETAIL MARKER

BUILDING ELEVATION MARKER

INTERIOR ELEVATION MARKER

NORTH ARROW

I PERSONALLY PREPARED THE PLANS SUBMITTED FOR THIS SINGLE FAMILY DWELLING TO BE OWNED AND OCCUPIED BY MYSELF.

OWNER SIGNATURE: \_\_\_\_\_

**MOORESTOWN RESIDENCE**  
WILLIAMS AVENUE, MOORSETOWN, NEW JERSEY

PROJECT TITLE:


**BASEMENT & ROOF PLANS / DETAILS**

SHEET TITLE:


AS NOTED	JES/MH
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FILE:	SHEET NUMBER:

**A1.3**

CONSTRUCTION DOCUMENT REVIEW SET  
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1 EAST ELEVATION  
SCALE: 1/8" = 1'-0"

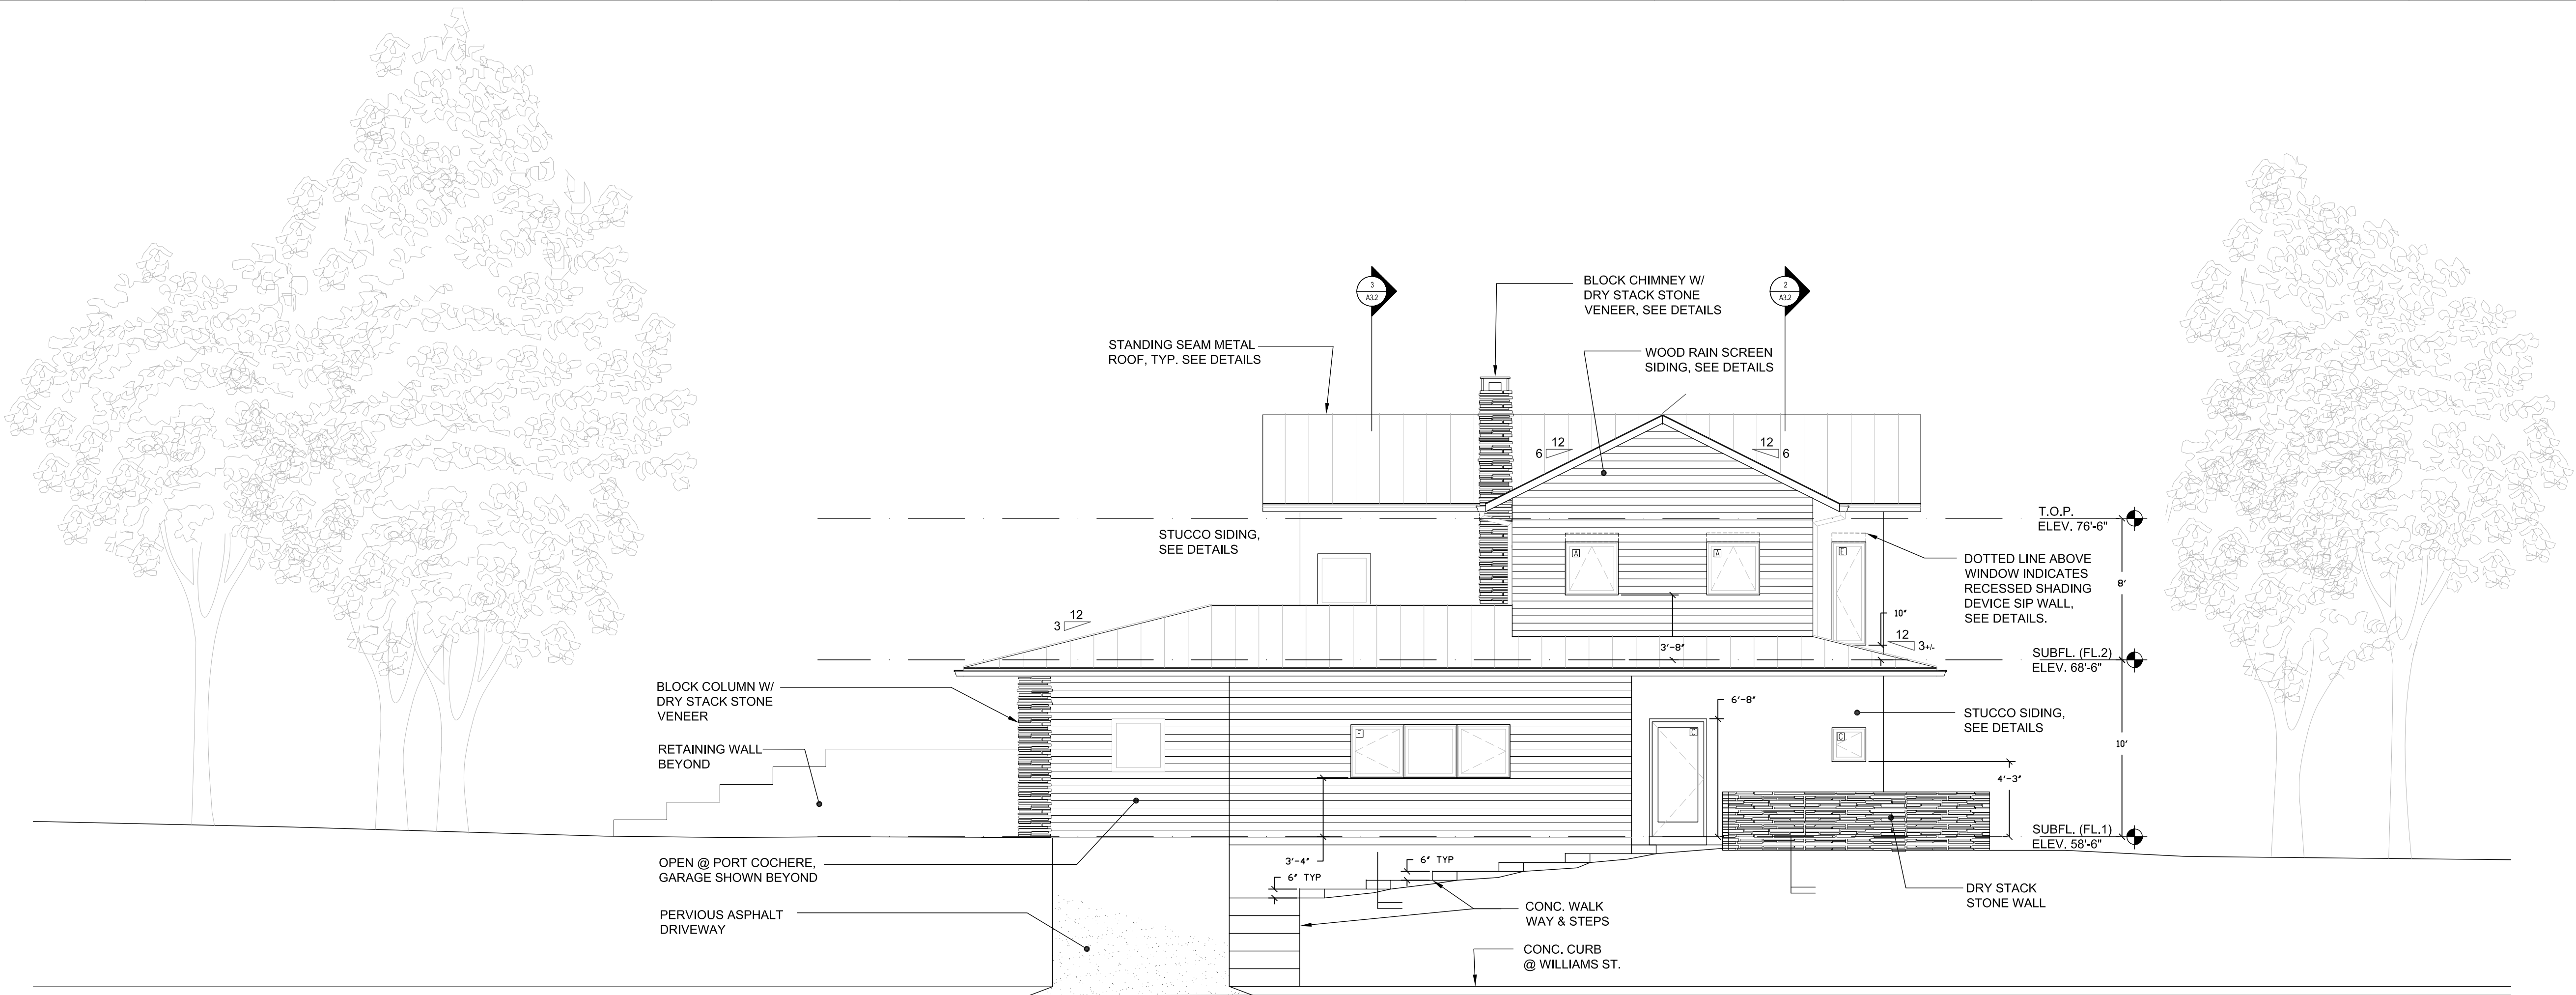

2 WEST ELEVATION @ ALCOVE  
SCALE: 1/8" = 1'-0"

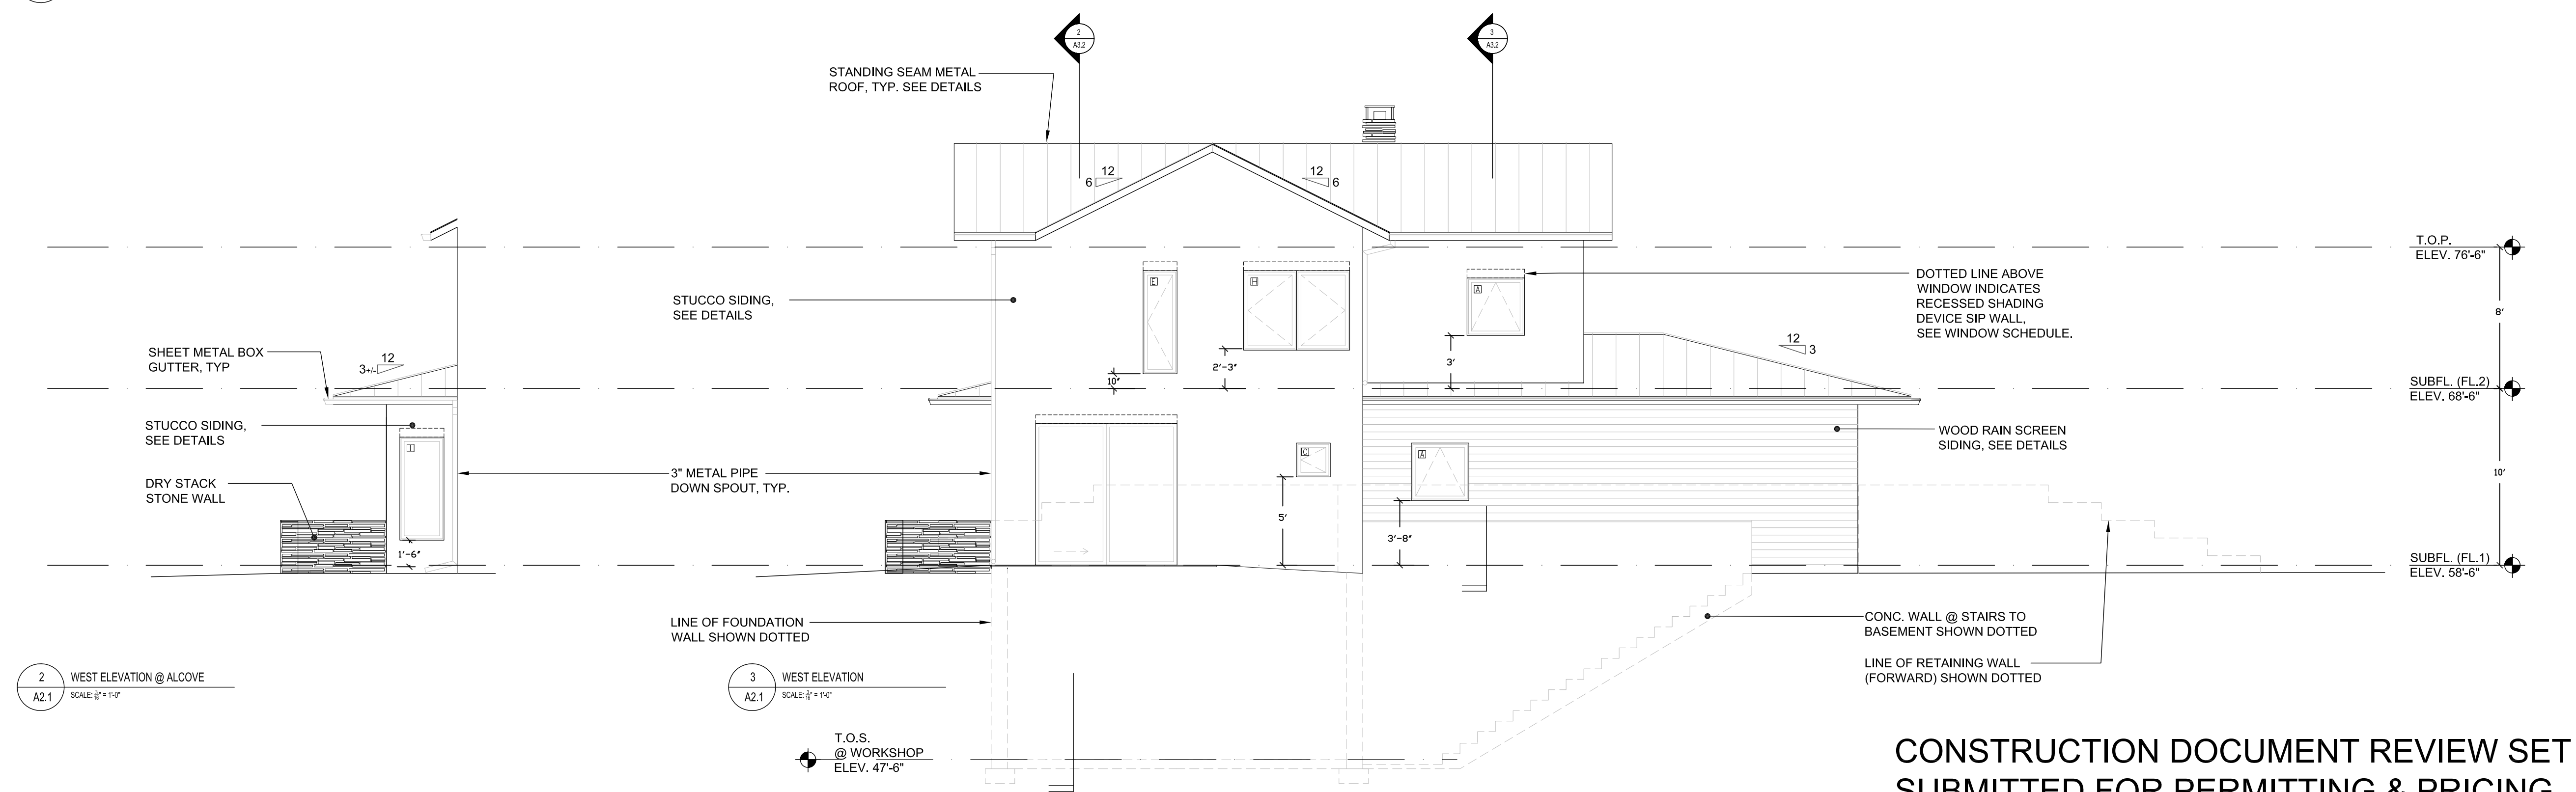3 WEST ELEVATION  
SCALE: 1/8" = 1'-0"

T.O.S.  
@ WORKSHOP  
ELEV. 47'-6"

CONSTRUCTION DOCUMENT REVIEW SET  
SUBMITTED FOR PERMITTING & PRICING.

GENERAL NOTES

1. SEE ELEVATIONS FOR WINDOW HEIGHTS FROM SUB-FLOOR. SEE PLAN FOR WINDOW LOCATIONS

ISSUE		
NO.	DATE	REMARKS
1.	5.7.10	PERMIT SET / BID SET

SYMBOLS KEY

WORK POINT

BUILDING SECTION MARKER

DETAIL SECTION MARKER

DETAIL MARKER

BUILDING ELEVATION MARKER

INTERIOR ELEVATION MARKER

NORTH ARROW

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OWNER SIGNATURE: \_\_\_\_\_

MOORSETOWN RESIDENCE

WILLIAMS AVENUE, MOORSETOWN, NEW JERSEY

PROJECT TITLE:

EAST & WEST ELEVATIONS

SHEET TITLE:

AS NOTED  
SCALE: 4.28.10  
DATE:

JES  
DRAWN BY:  
JES  
CHECKED BY:


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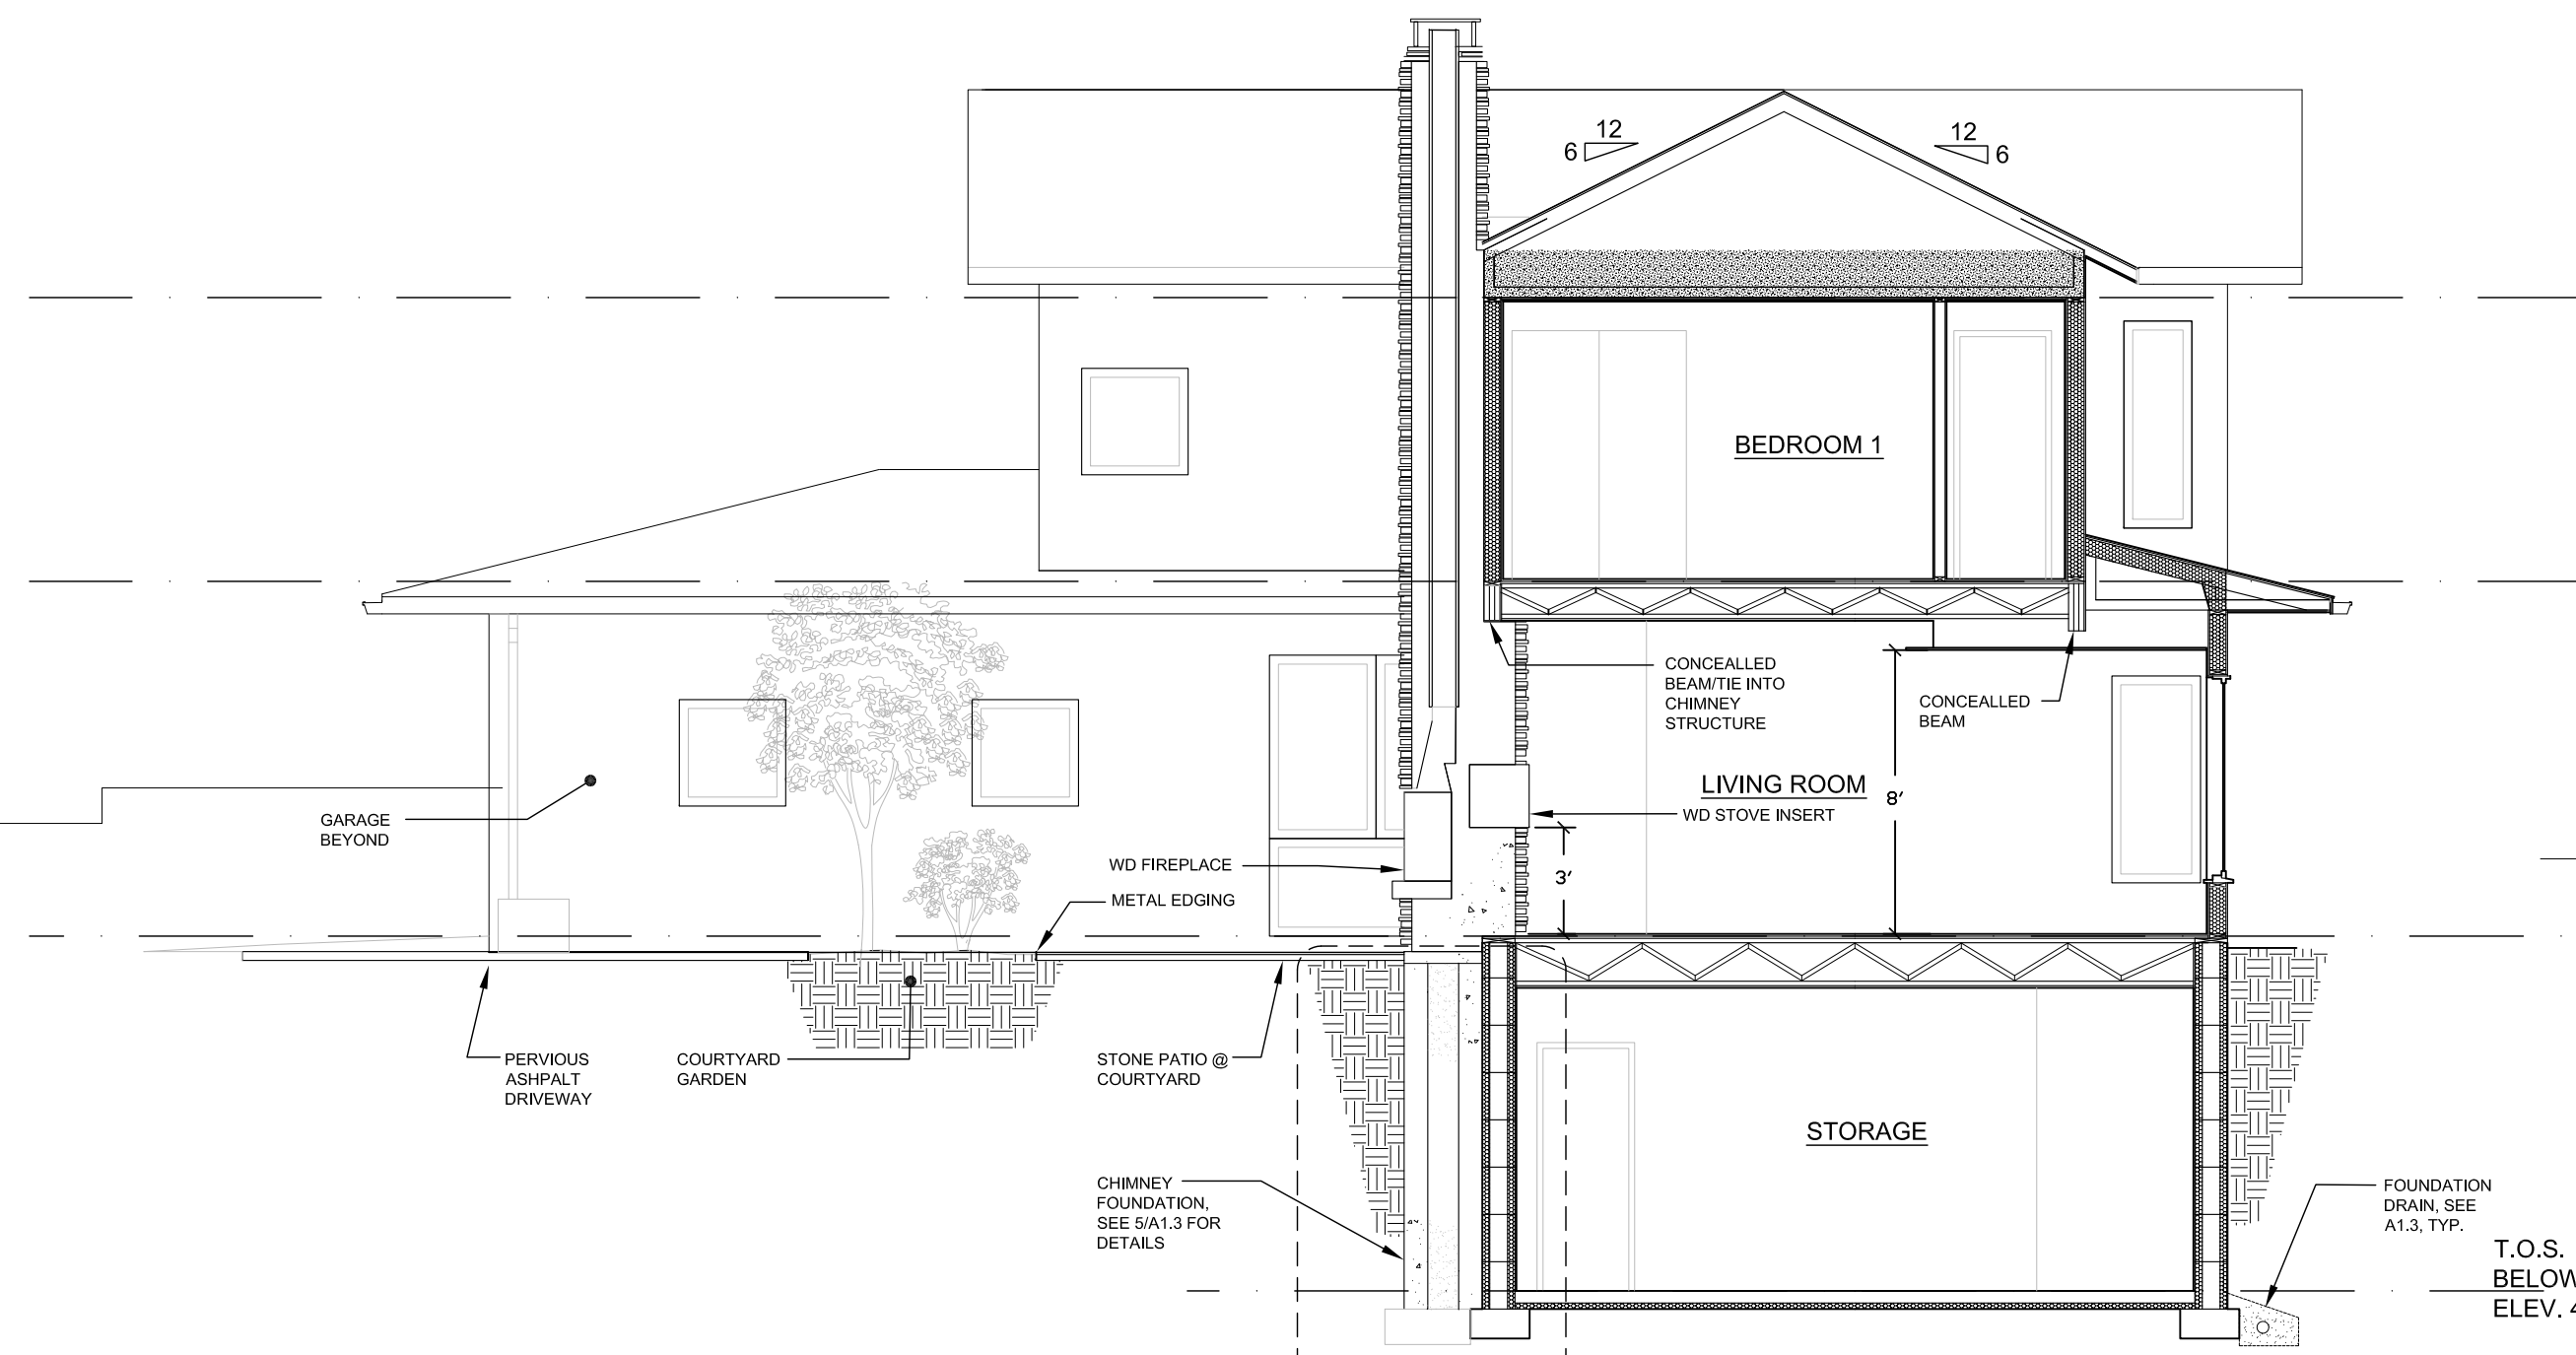
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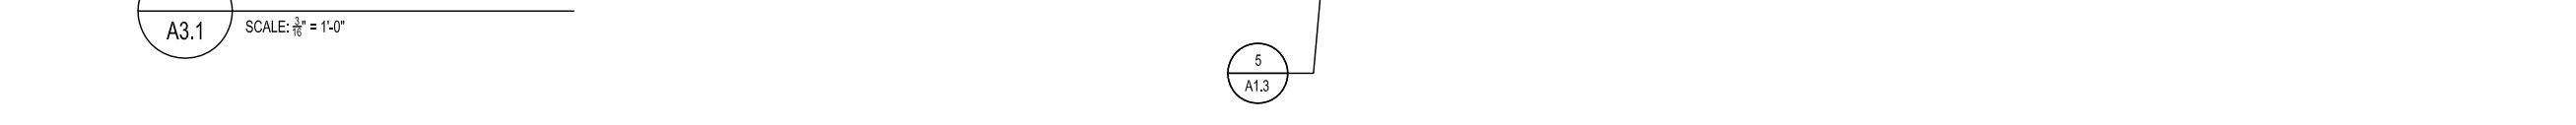
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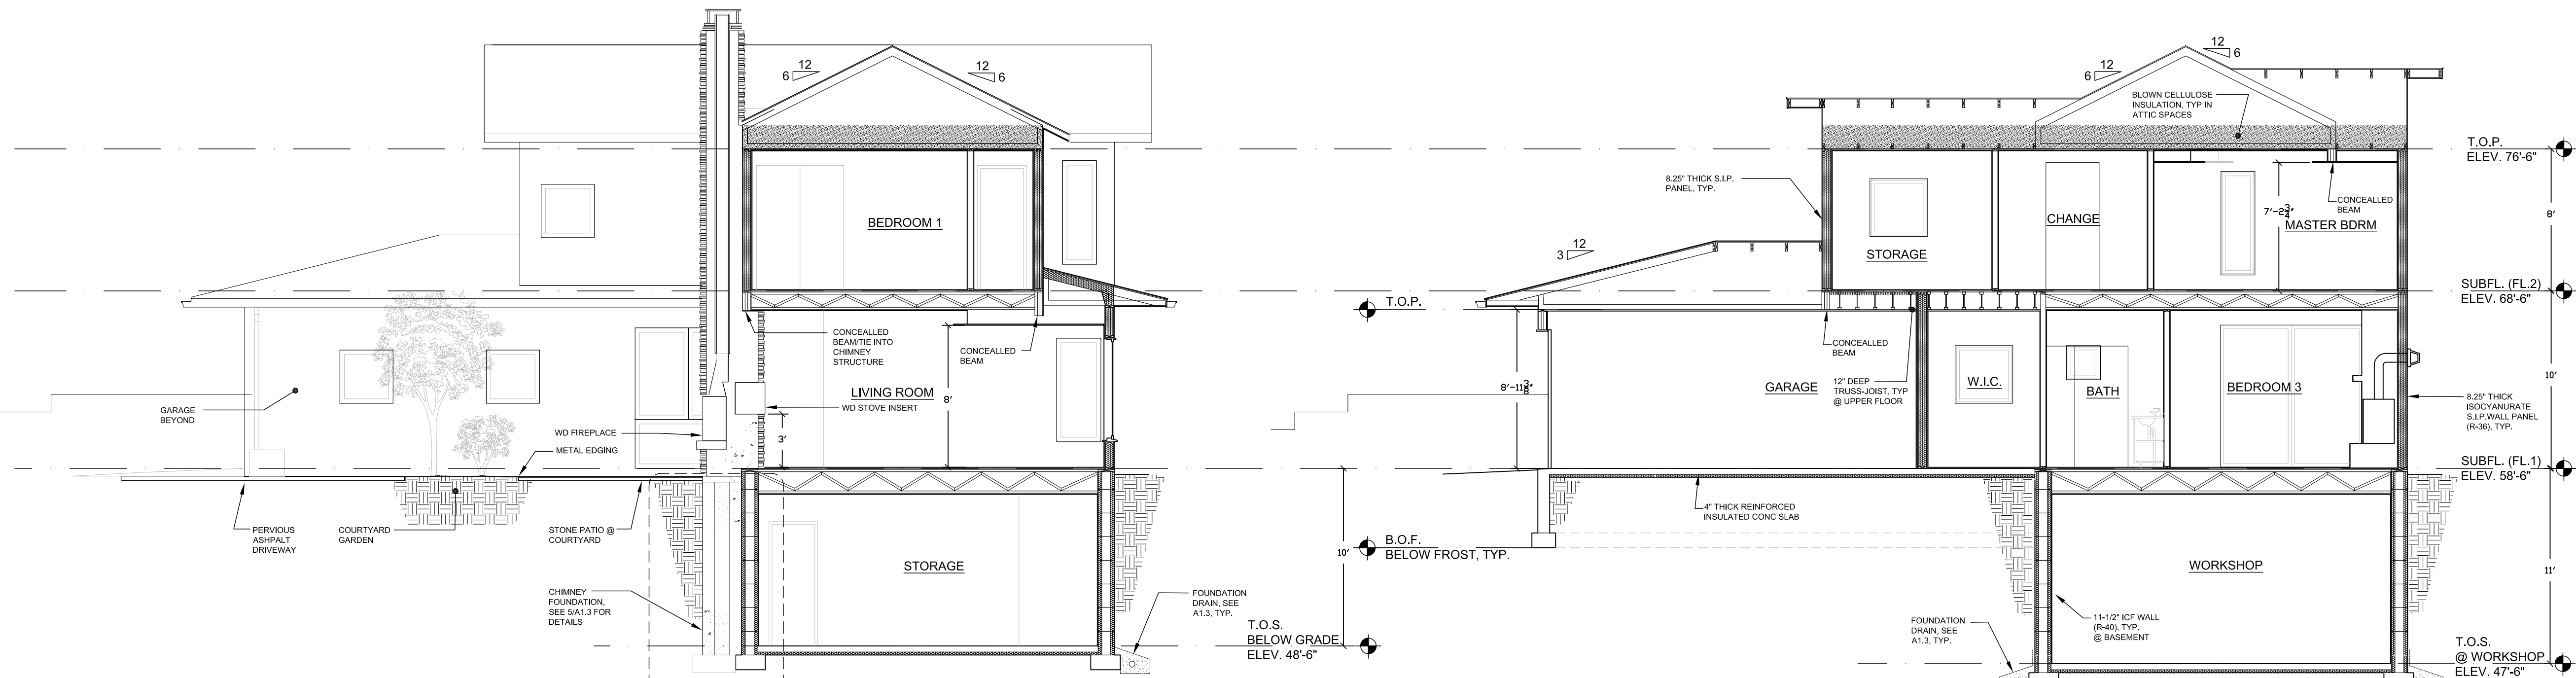
1 TRANSVERSE SECTION 1  
A3.1 SCALE: 3/8" = 1'-0"



2 TRANSVERSE SECTION 2  
A3.1 SCALE: 3/8" = 1'-0"



4 TRANSVERSE SECTION 3  
A3.1 SCALE: 3/8" = 1'-0"

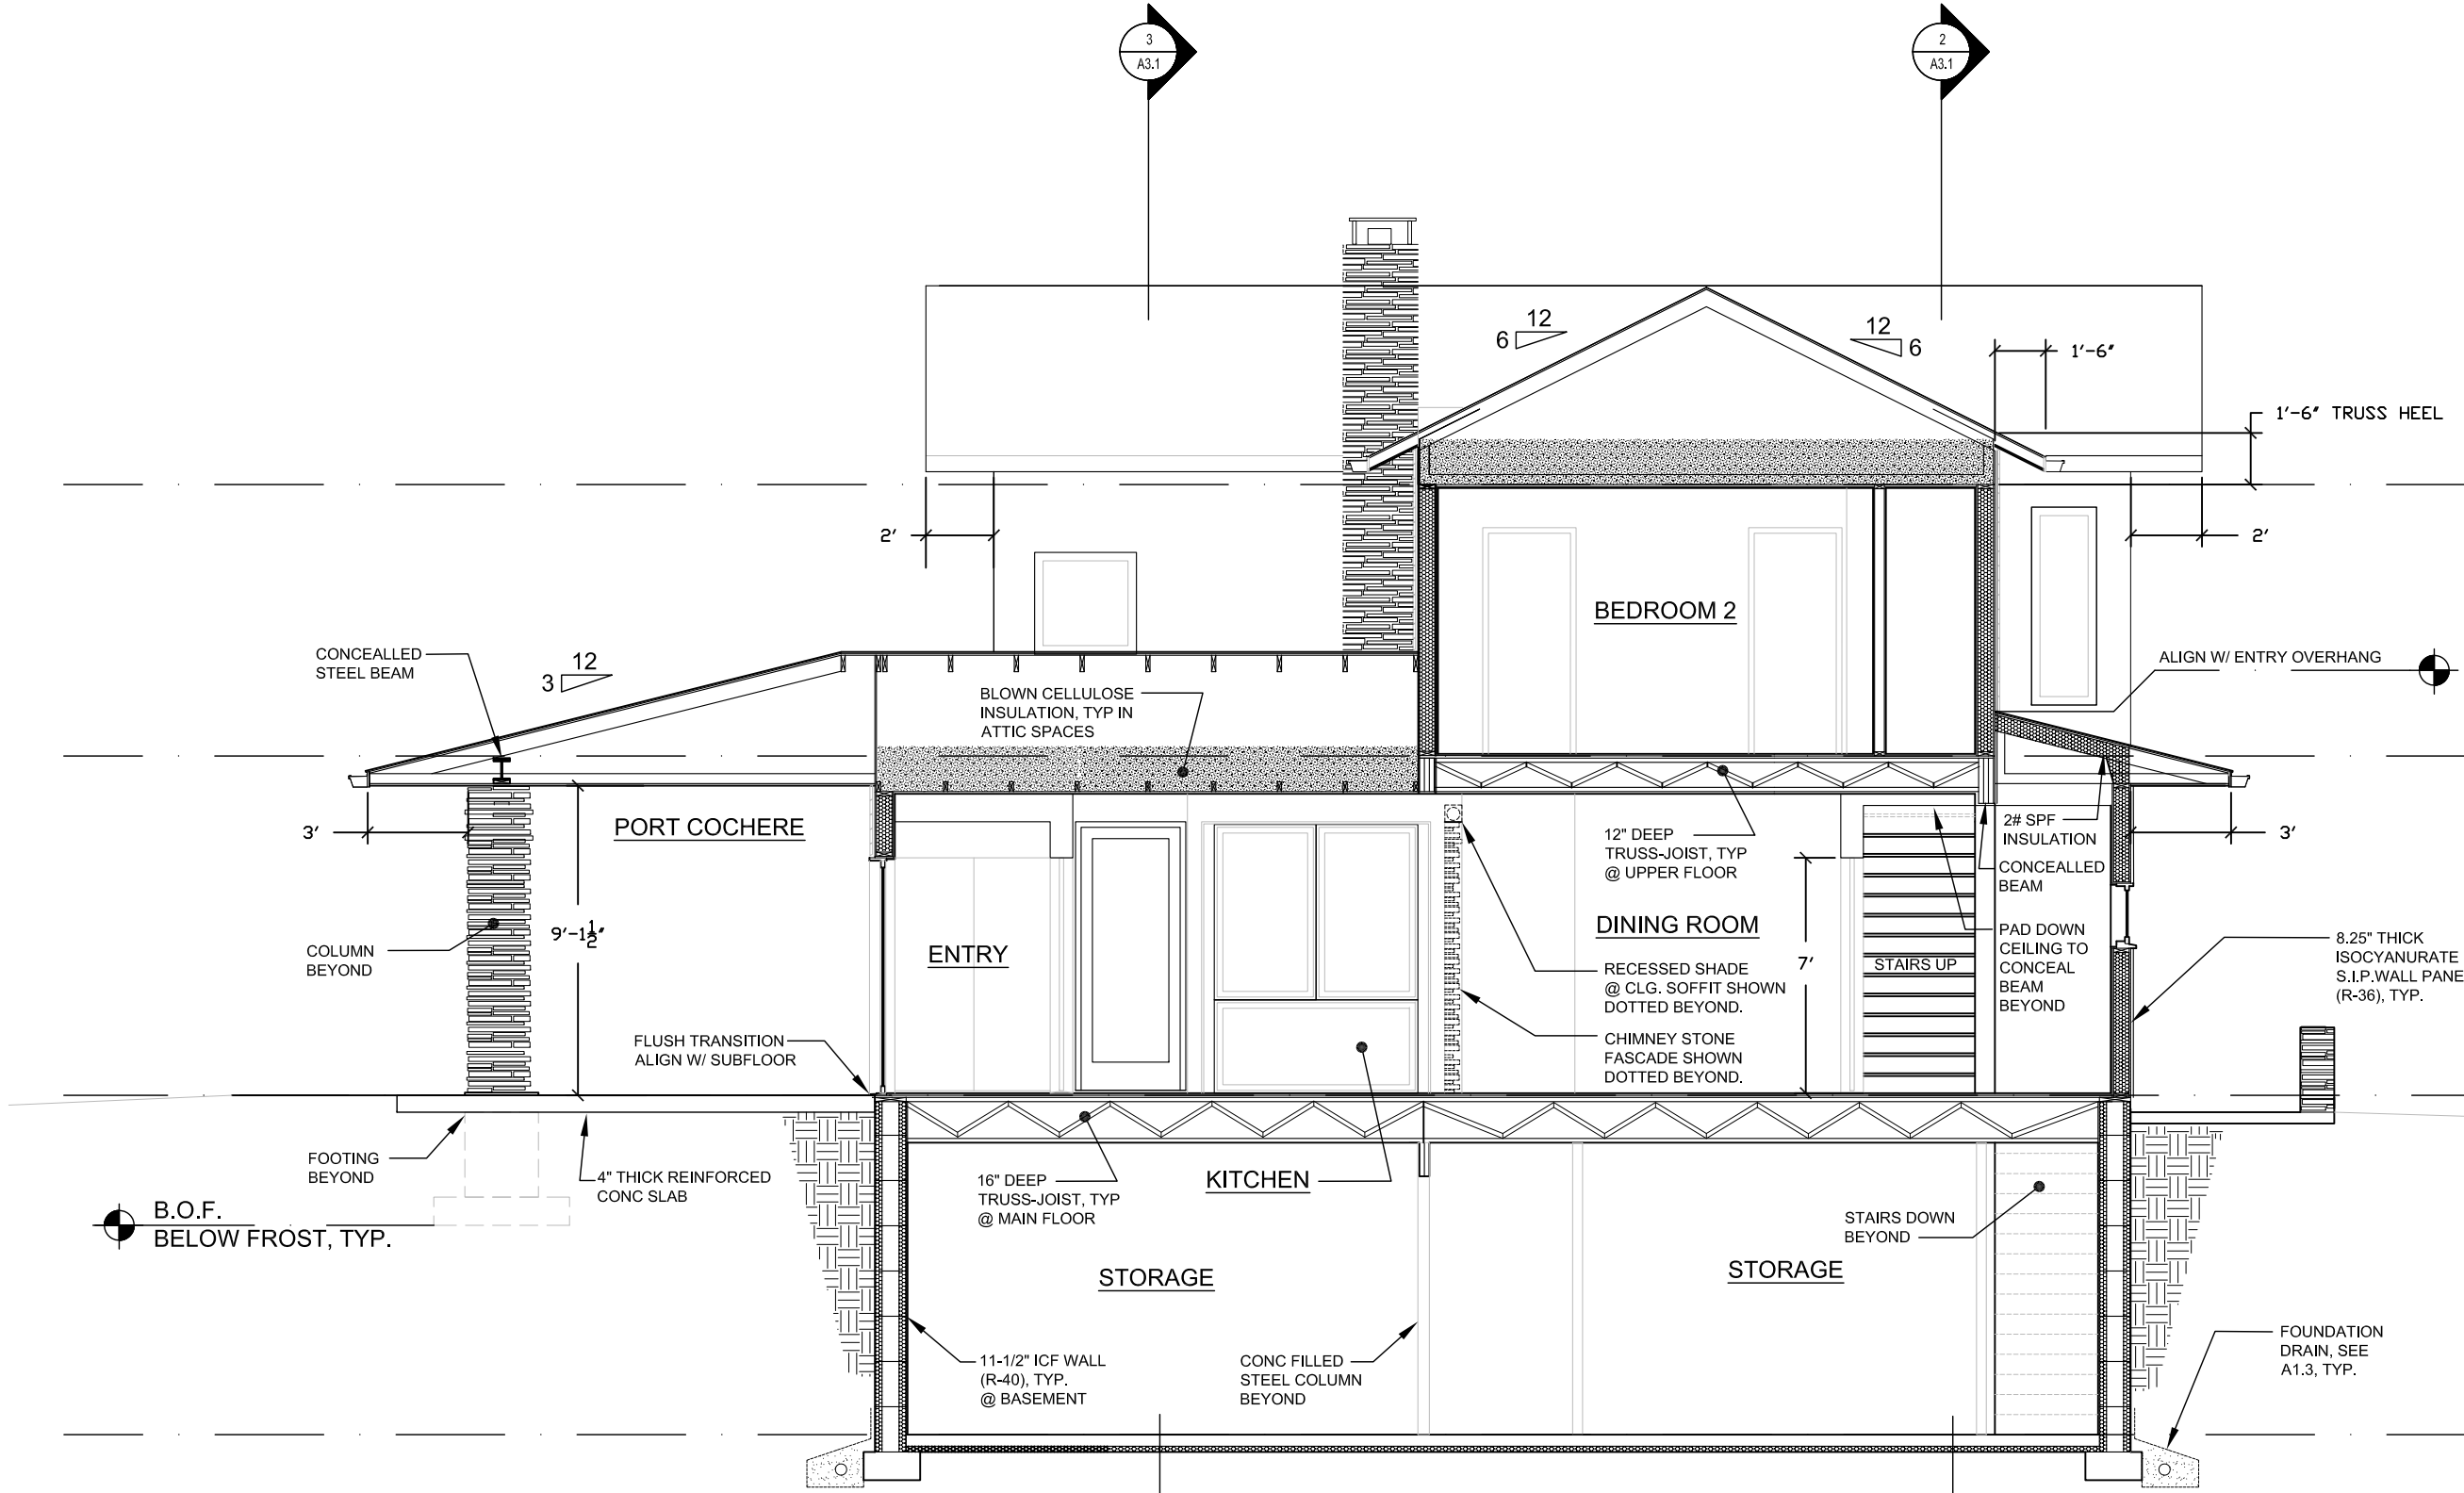

3 TRANSVERSE SECTION 4  
A3.1 SCALE: 3/8" = 1'-0"

CONSTRUCTION DOCUMENT REVIEW SET  
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GENERAL NOTES

1. FOUNDATION WALLS TO BE 11.5" ICF SEE A1.3 FOR NOTES & DETAILS. PROVIDE JOIST HANGERS PER MANUFACTURERS SPECIFICATIONS.

2. WALL CONSTRUCTION TO BE 8.25" THICK ISOCYANURATE STRUCTURAL INSULATED PANEL (S.I.P.), TYP.

ISSUE	
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SYMBOLS KEY

WORK POINT

BUILDING SECTION MARKER

DETAIL SECTION MARKER

DETAIL MARKER

BUILDING ELEVATION MARKER

INTERIOR ELEVATION MARKER

NORTH ARROW

I PERSONALLY PREPARED THE PLANS SUBMITTED FOR THIS SINGLE FAMILY DWELLING TO BE OWNED AND OCCUPIED BY MYSELF.

OWNER SIGNATURE: \_\_\_\_\_

MOORSETOWN RESIDENCE

WILLIAMS AVENUE, MOORSETOWN, NEW JERSEY


PROJECT TITLE:

TRANSVERSE BUILDING SECTIONS

SHEET TITLE:	
AS NOTED	JES/MH
SCALE:	DRAWN BY:
4.28.10	JES
DATE:	CHECKED BY:
FILE:	SHEET NUMBER


A3.1



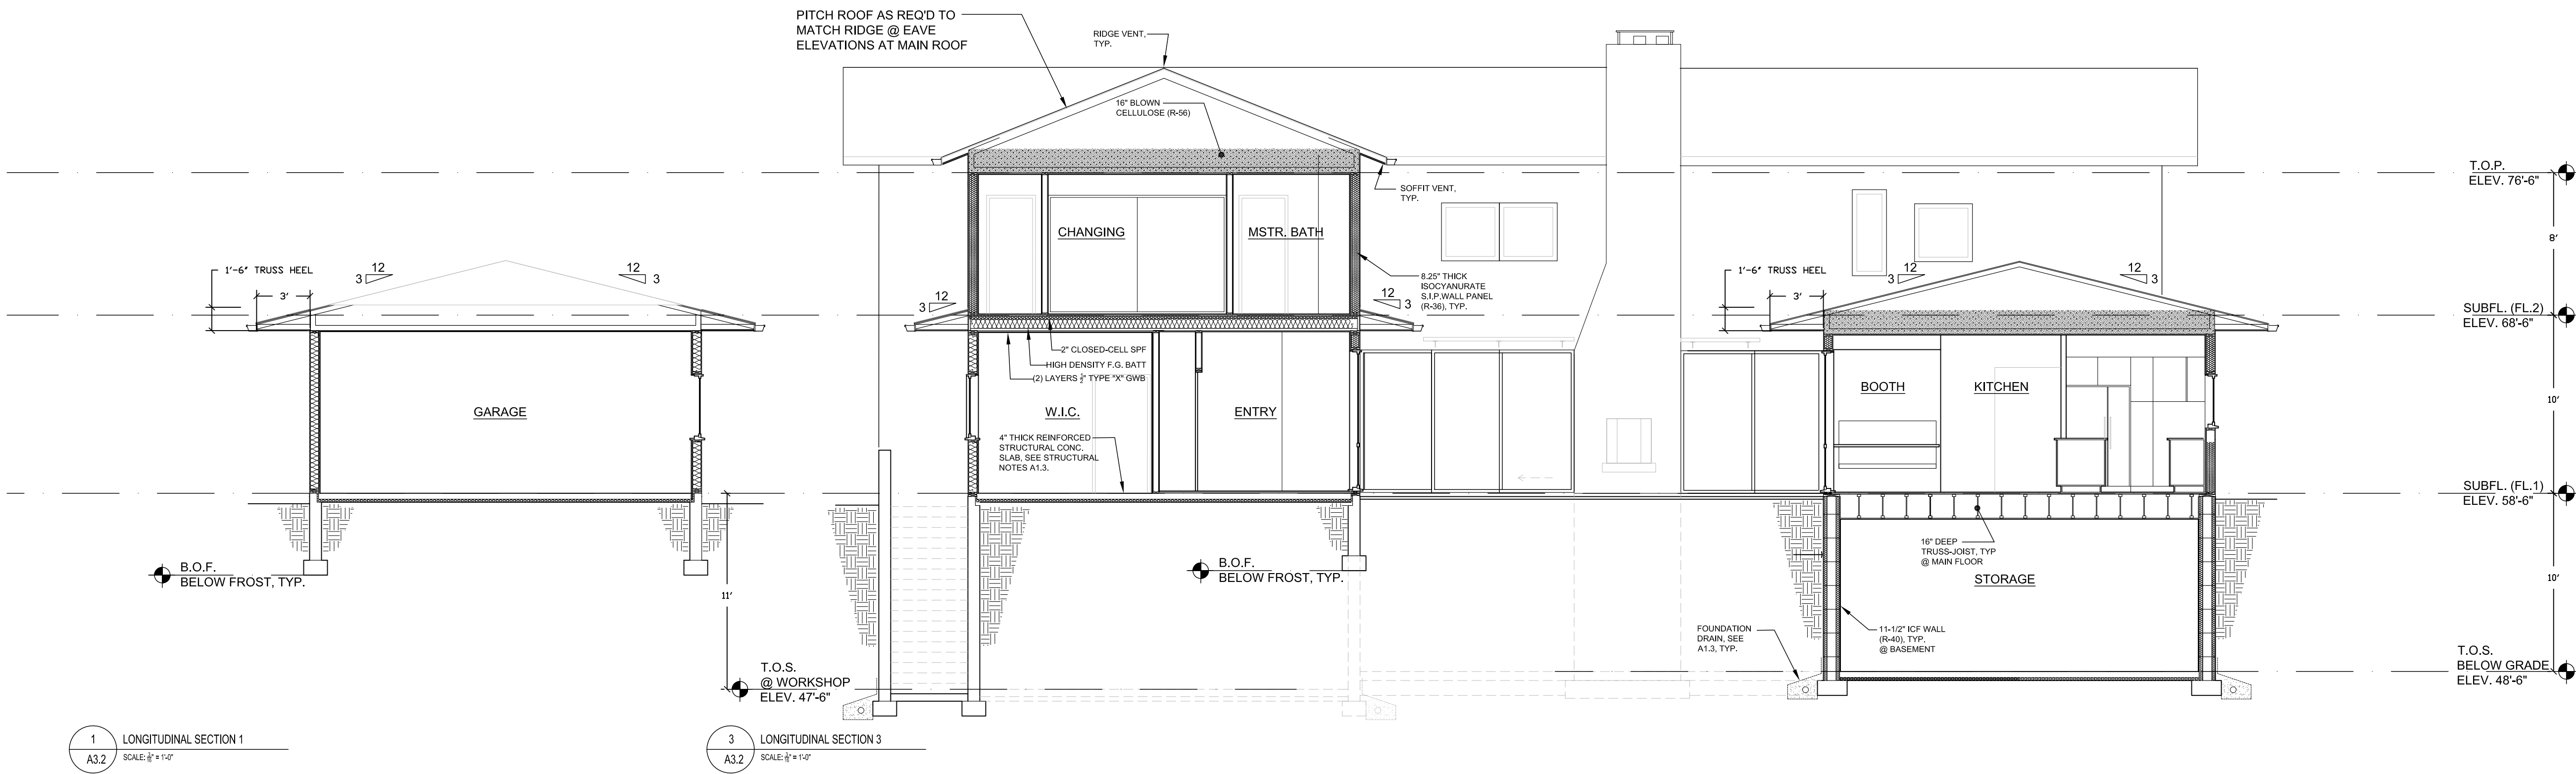

1 LONGITUDINAL SECTION 1  
A3.2 SCALE: 3/8" = 1'-0"

3 LONGITUDINAL SECTION 3  
A3.2 SCALE: 3/8" = 1'-0"

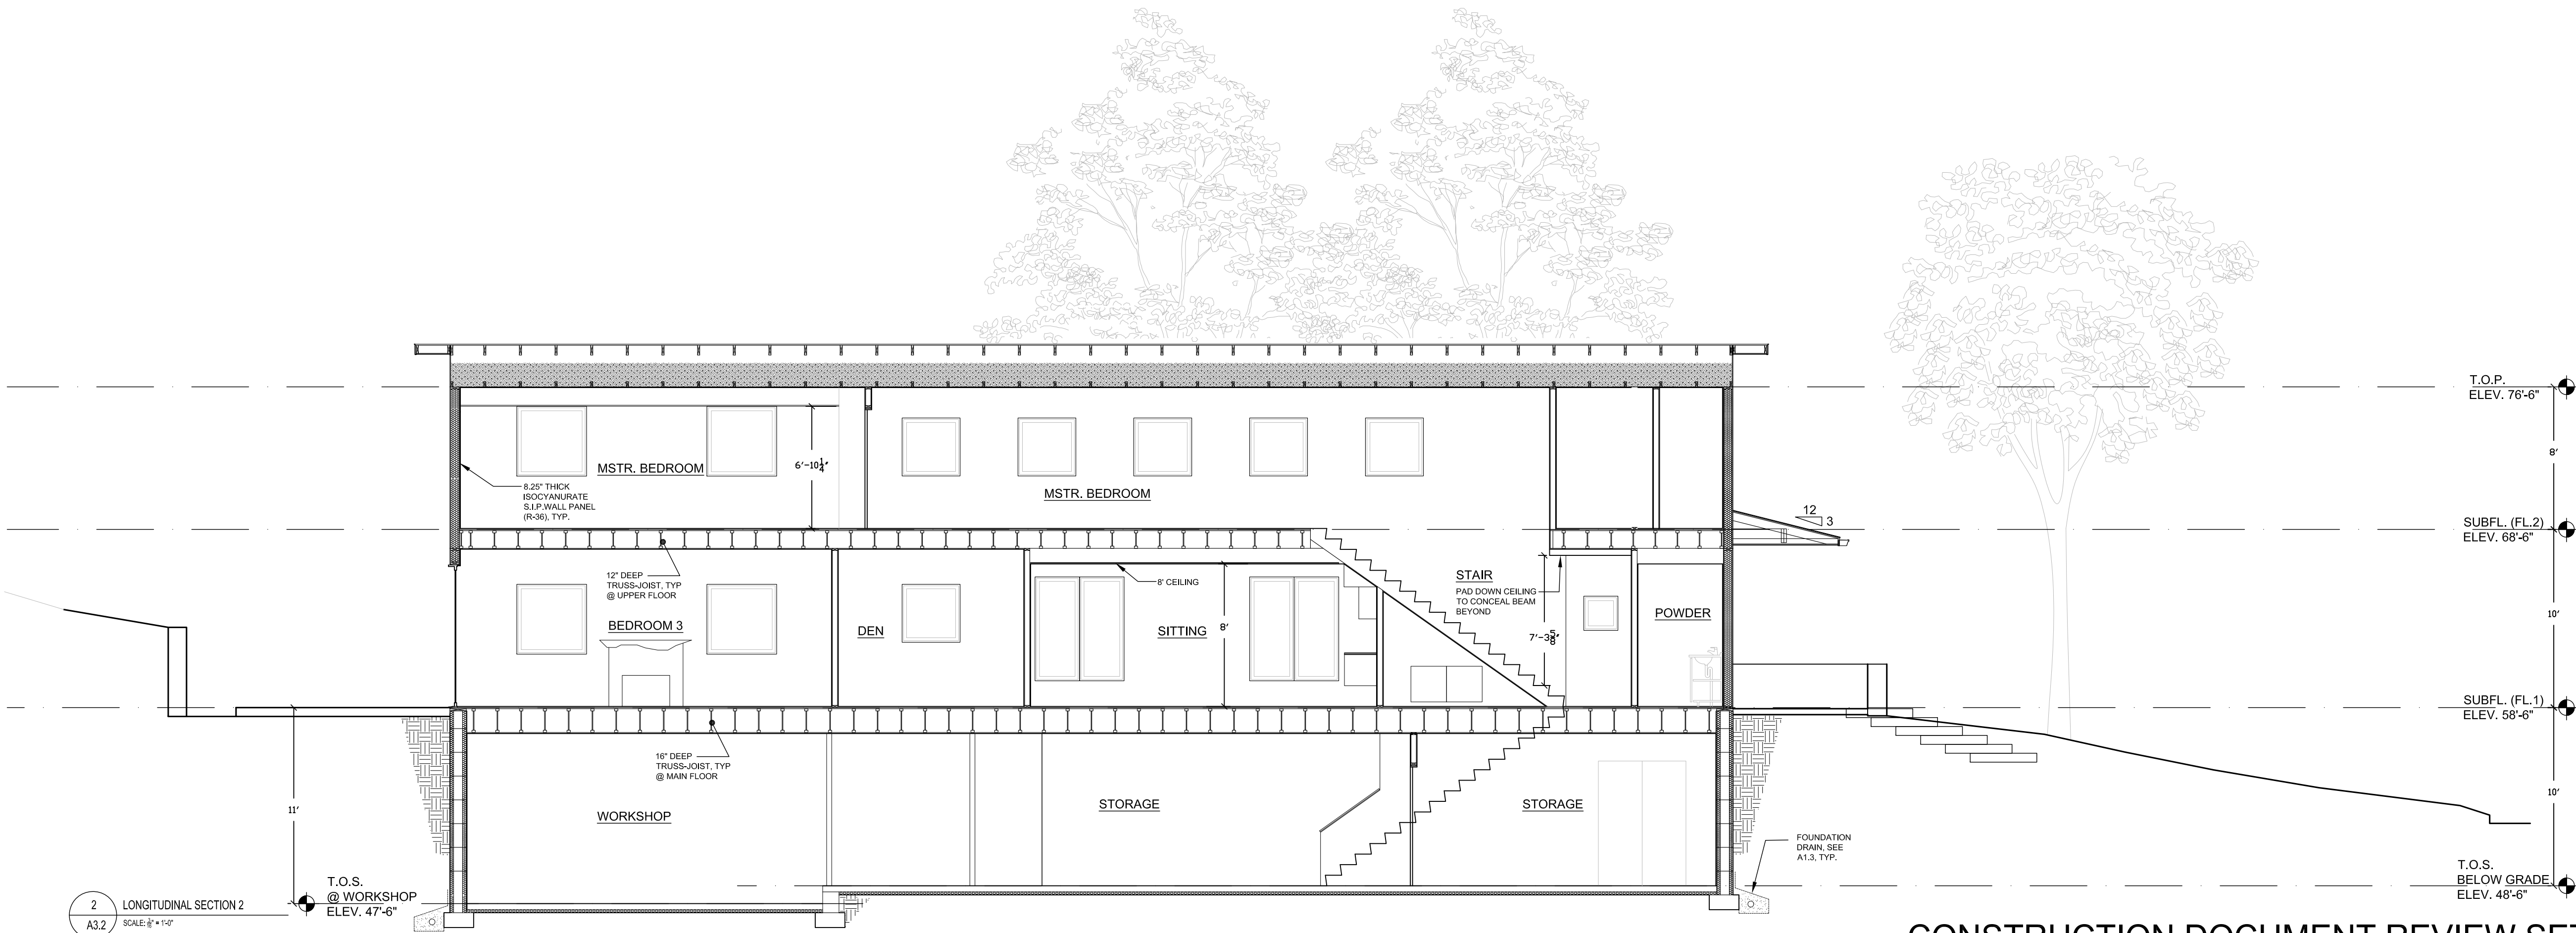

2 LONGITUDINAL SECTION 2  
A3.2 SCALE: 3/8" = 1'-0"

- GENERAL NOTES**
- FOUNDATION WALLS TO BE 11.5" ICF SEE A1.3 FOR NOTES & DETAILS. PROVIDE JOIST HANGERS PER MANUFACTURERS SPECIFICATIONS.
  - WALL CONSTRUCTION TO BE 8.25" THICK ISOCYANURATE STRUCTURAL INSULATED PANEL (S.I.P.), TYP.

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WORK POINT	
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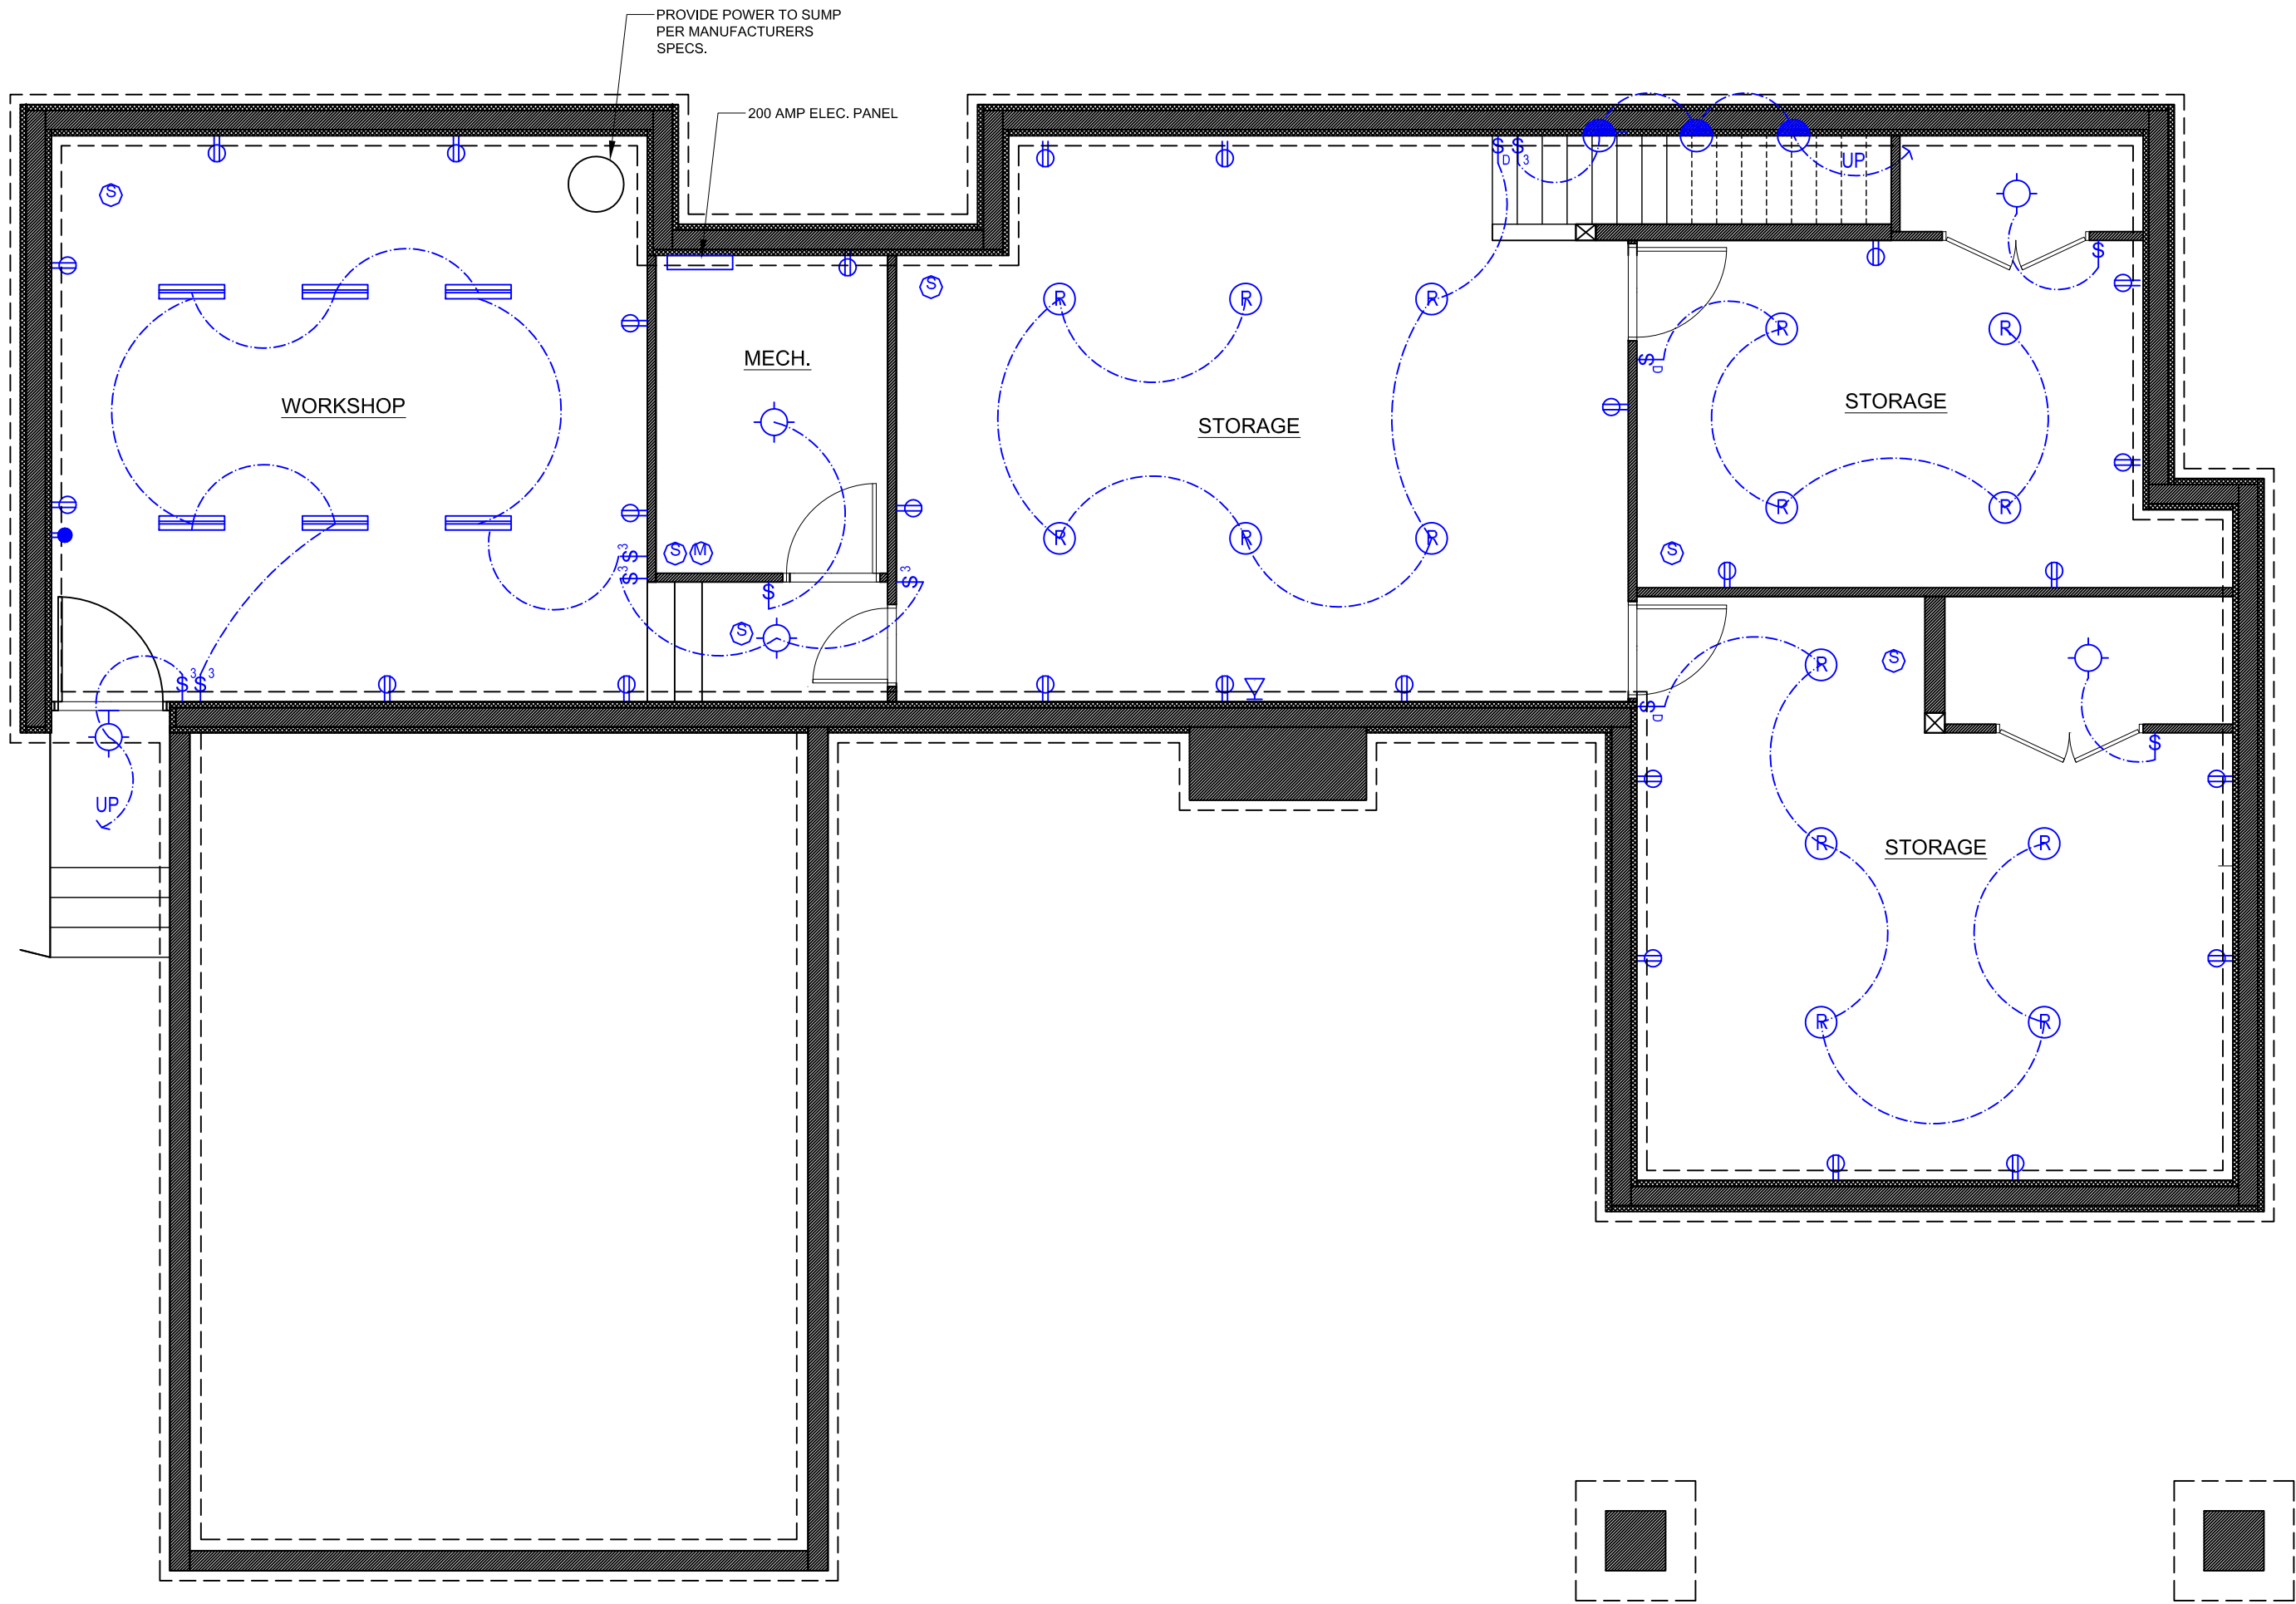
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OWNER SIGNATURE: \_\_\_\_\_

**MOORSETOWN RESIDENCE**  
WILLIAMS AVENUE, MOORSETOWN, NEW JERSEY

PROJECT TITLE:			
LONGITUDINAL BUILDING SECTIONS			
SHEET TITLE:			
AS NOTED		JES/MH	
SCALE:	DRAWN BY:		
4.28.10	JES		
DATE:	CHECKED BY:		
		A3.2	
FILE:		SHEET NUMBER:	

CONSTRUCTION DOCUMENT REVIEW SET  
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1  
E1.1  
ELECTRICAL PLAN BASEMENT LEVEL  
SCALE: 3/8" = 1'-0"

ELECTRICAL SYMBOLS

- |                                   |                                               |                               |                                 |
|-----------------------------------|-----------------------------------------------|-------------------------------|---------------------------------|
| S SINGLE POLE SWITCH              | ⏏ DUPLICATION OUTLET W/ TOP OUTLET SWITCHED   | ⦿ RECESSED DOWNLIGHT          | ⚡ FLOOD LIGHT                   |
| ⏏ SINGLE POLE SWITCH W/ DIMMER    | ⏏ GROUND FAULT INTERRUPTED DUPLICATION OUTLET | ⦿ RECESSED WALL WASH          | ⦿ PATH LIGHTING                 |
| ⏏ THREE POLE SWITCH               | ⏏ WATERPROOF / OUTDOOR OUTLET                 | ⦿ RECESSED DIRECTIONAL        | ⦿ LED STRIP LIGHT               |
| ⏏ JAMB SWITCH                     | ⏏ FLOOR DUPLICATION OUTLET W/ COVER PLATE     | ⦿ SURFACE MOUNTED             | ⦿ LED COVE UPLIGHT              |
| ⏏ SWITCH W/ PILOT LIGHT           | ⏏ QUADRUPLICATION OUTLET                      | ⦿ WALL MOUNTED                | ⦿ FLORESCENT 4' SHOP LIGHT      |
| ⏏ GARGAGE DOOR OPENER             | ⏏ SPECIAL OUTLET                              | ⦿ SURFACE MOUNTED TRACK LIGHT | ⦿ EXHAUST FAN ON TIMER          |
| ⏏ PULL CHAIN                      | ⏏ COVERED JUNCTION BOX                        | ⦿ RECESSED STRIP LIGHT        | ⦿ EXHAUST FAN ON TIMER W/ LIGHT |
| ⏏ TELEPHONE OUTLET                | ⦿ RECESSED AUDIO SPEAKER                      | ⦿ CEILING FAN                 | ⦿ THERMOSTAT                    |
| ⏏ CABLE TELEVISION OUTLET         | ⦿ AUDIO HUB / POWER SOURCE                    | ⦿ CEILING FAN W/ LIGHT        | ⦿ SMOKE DETECTOR (HARDWIRED)    |
| ⏏ DUPLICATION OUTLET              | ⦿ MOTORIZED SHADING CONTROLS                  |                               | ⦿ CARBON MONOXIDE DETECTOR      |
| ⏏ DUPLICATION OUTLET @ 42" A.F.F. | ⦿ MOTORIZED SHADES                            |                               | ⦿ HOUSE VACUUM PORT             |

CONSTRUCTION DOCUMENT REVIEW SET  
SUBMITTED FOR PERMITTING & PRICING.

GENERAL NOTES

1. ALL CONDUIT TO BE ARMORED CABLE, TYP.
2. CONDUIT TO BE RUN IN SIP WALLS PER MANUFACTURERS SPECIFICATIONS.
3. PROVIDE WIRING AND VOLTAGE REQUIREMENTS FOR ALL APPLIANCES AND MOTORIZED SHADING DEVICES PER MANUFACTURERS SPECIFICATIONS.
4. ALL RECEPTACLES TO BE 20 AMP CAPACITY
5. ALL RECESS LIGHTING IN ATTIC OR OTHER INSULATED SPACES TO BE THERMALLY RATED & RATED FOR PROXIMITY TO COMBUSTIBLE MATERIALS.
6. ALL EXTERIOR LIGHTING TO BE RATED FOR OUTDOOR USE.
7. OWNER TO PROVIDE DIMENSIONAL LAYOUT OF LIGHTS AND FIXTURES PRIOR TO INSTALLATION OF WORK.
8. OWNER TO PROVIDE SPEC SHEETS FOR ALL APPLIANCES, HARDWARE, LIGHTS, AND FIXTURES PRIOR TO INSTALLATION OF WORK.

ISSUE

NO.	DATE	REMARKS
1.	5.7.10	PERMIT SET / BID SET

SYMBOLS KEY

WORK POINT	⦿
BUILDING SECTION MARKER	⦿
DETAIL SECTION MARKER	⦿
DETAIL MARKER	⦿
BUILDING ELEVATION MARKER	⦿
INTERIOR ELEVATION MARKER	⦿
NORTH ARROW	⦿

I PERSONALLY PREPARED THE PLANS SUBMITTED FOR THIS SINGLE FAMILY DWELLING TO BE OWNED AND OCCUPIED BY MYSELF.

OWNER SIGNATURE: \_\_\_\_\_

MOORESTOWN  
RESIDENCE


WILLIAMS AVENUE, MOORSETOWN, NEW JERSEY

PROJECT TITLE:

ELECTRICAL PLAN BASEMENT LEVEL

AS NOTED	JES/MH	E1.1
SCALE:	DRAWN BY:	
4.28.10	JES	
DATE:	CHECKED BY:	
FILE:	SHEET NUMBER:	



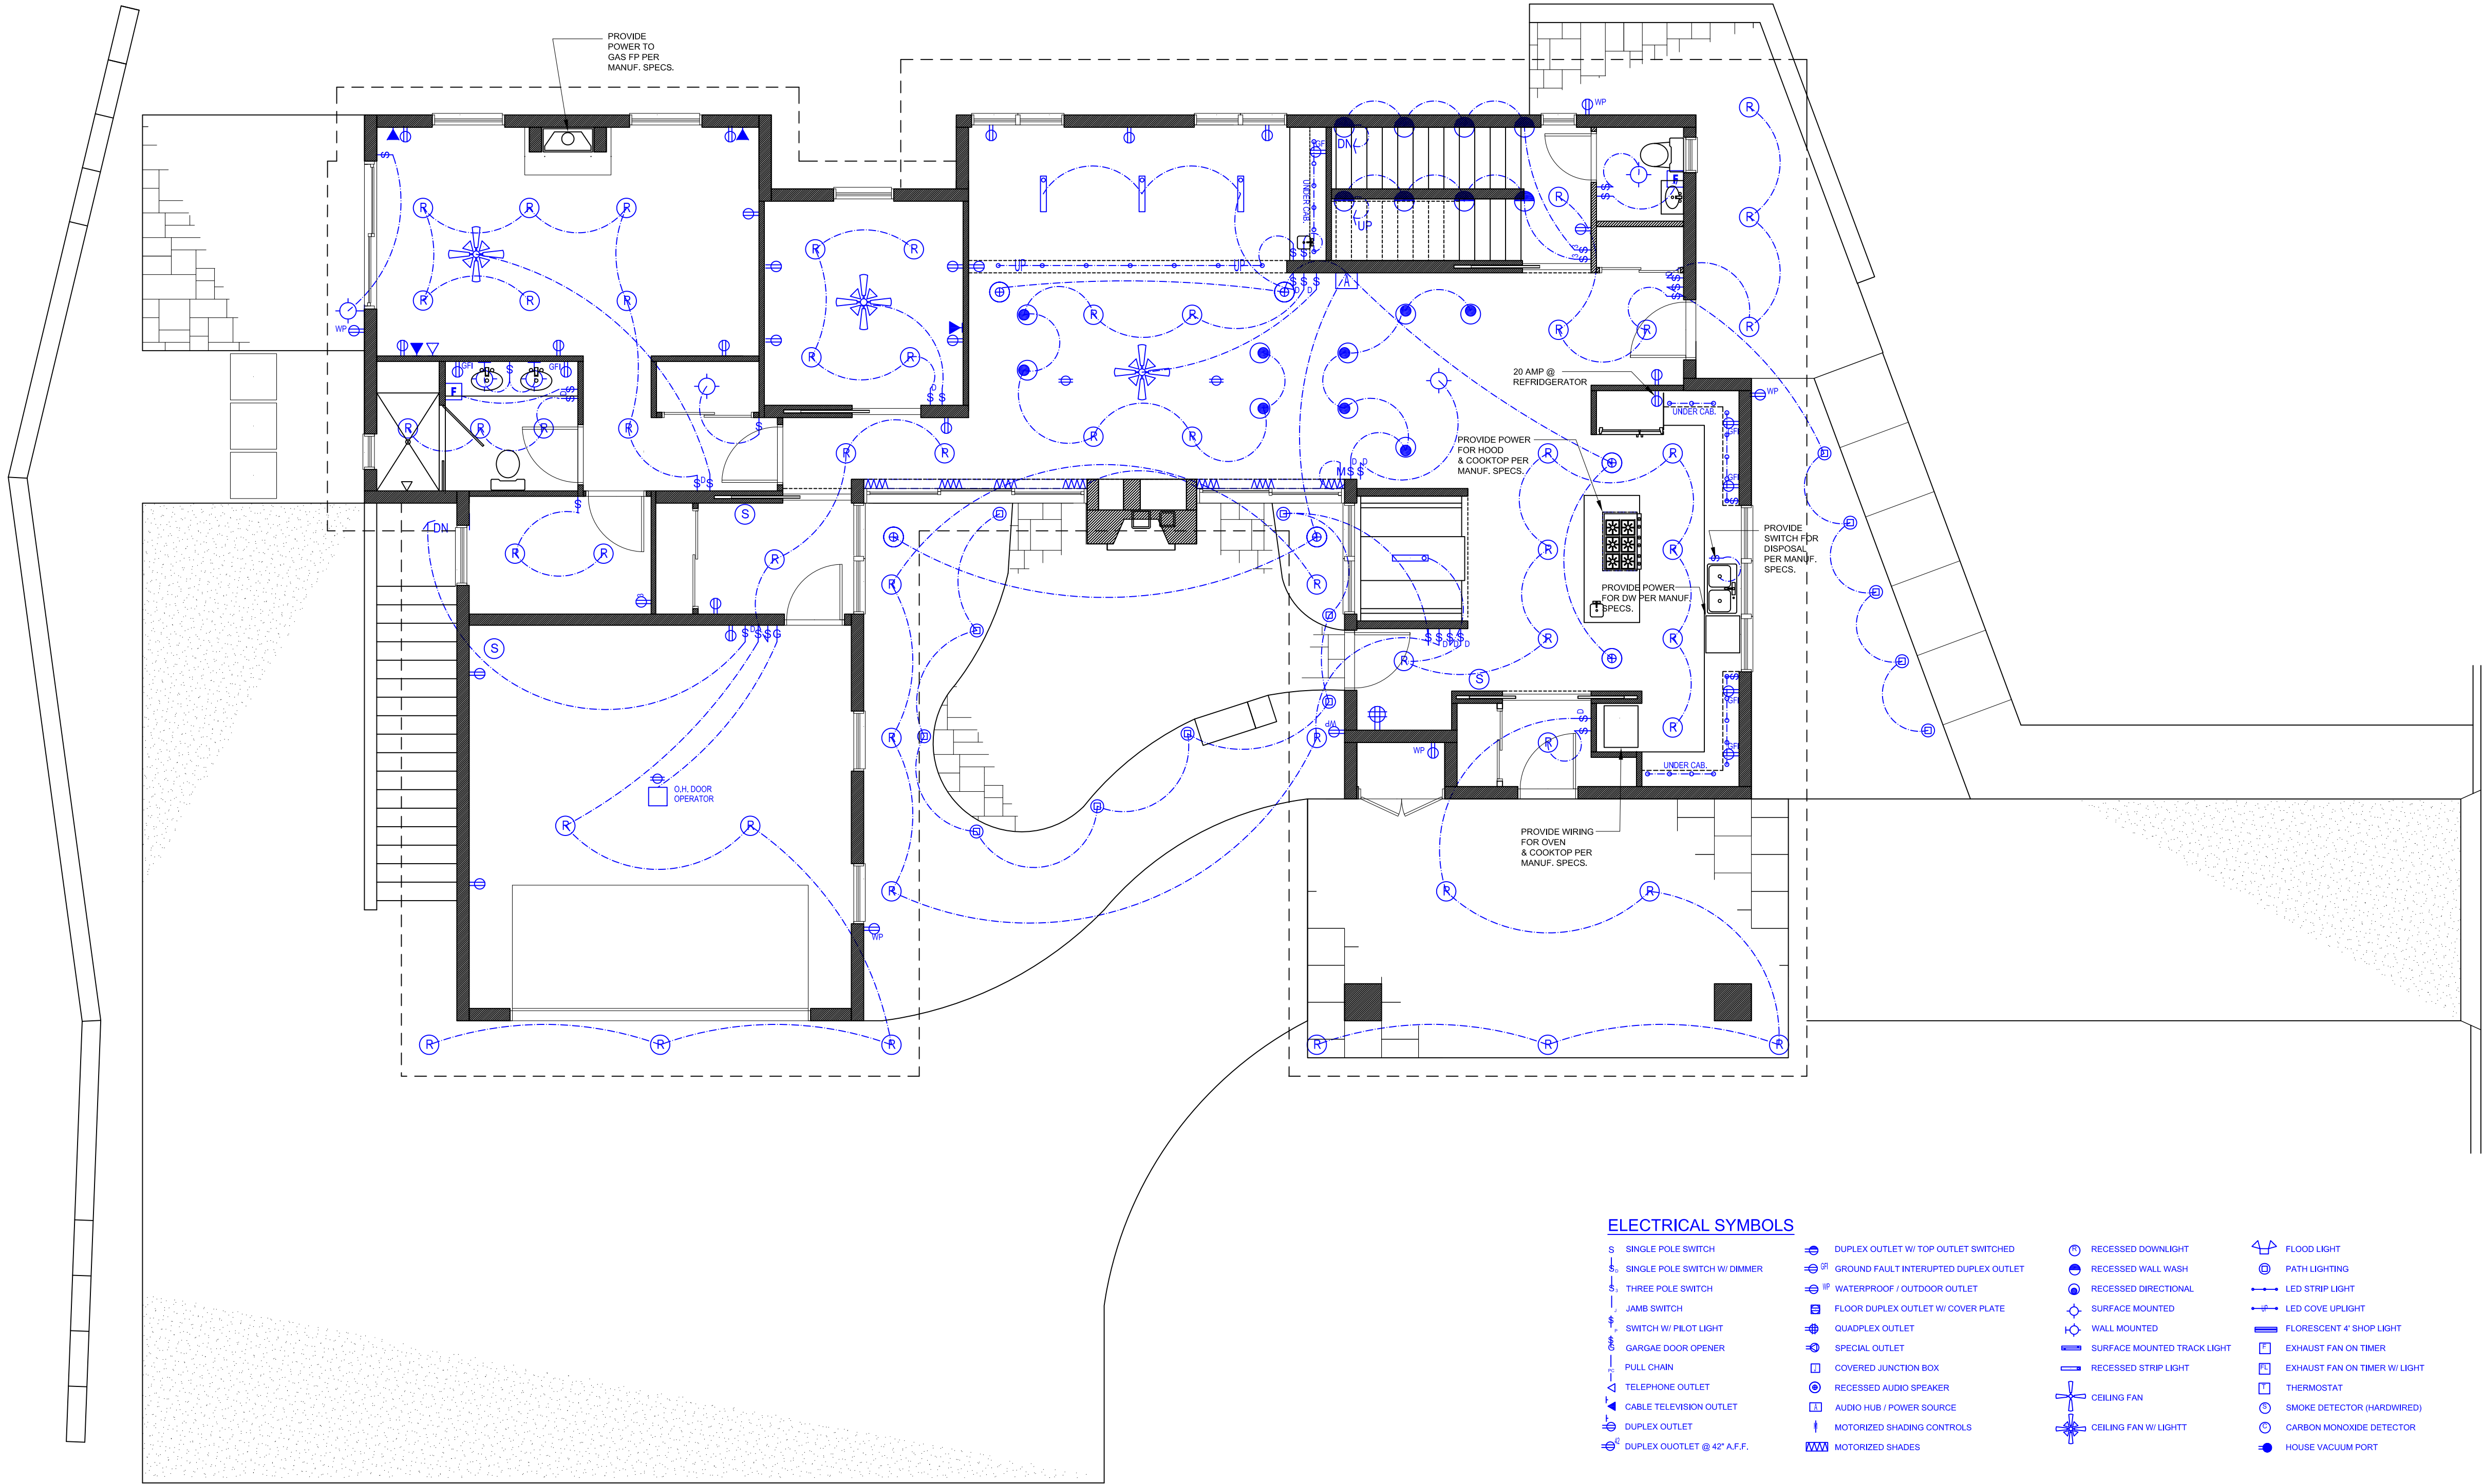

- GENERAL NOTES**
1. ALL CONDUIT TO BE ARMORED CABLE, TYP.
  2. CONDUIT TO BE RUN IN SIP WALLS PER MANUFACTURERS SPECIFICATIONS.
  3. PROVIDE WIRING AND VOLTAGE REQUIREMENTS FOR ALL APPLIANCES AND MOTORIZED SHADING DEVICES PER MANUFACTURERS SPECIFICATIONS.
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  5. ALL RECESS LIGHTING IN ATTIC OR OTHER INSULATED SPACES TO BE THERMALLY RATED & RATED FOR PROXIMITY TO COMBUSTIBLE MATERIALS.
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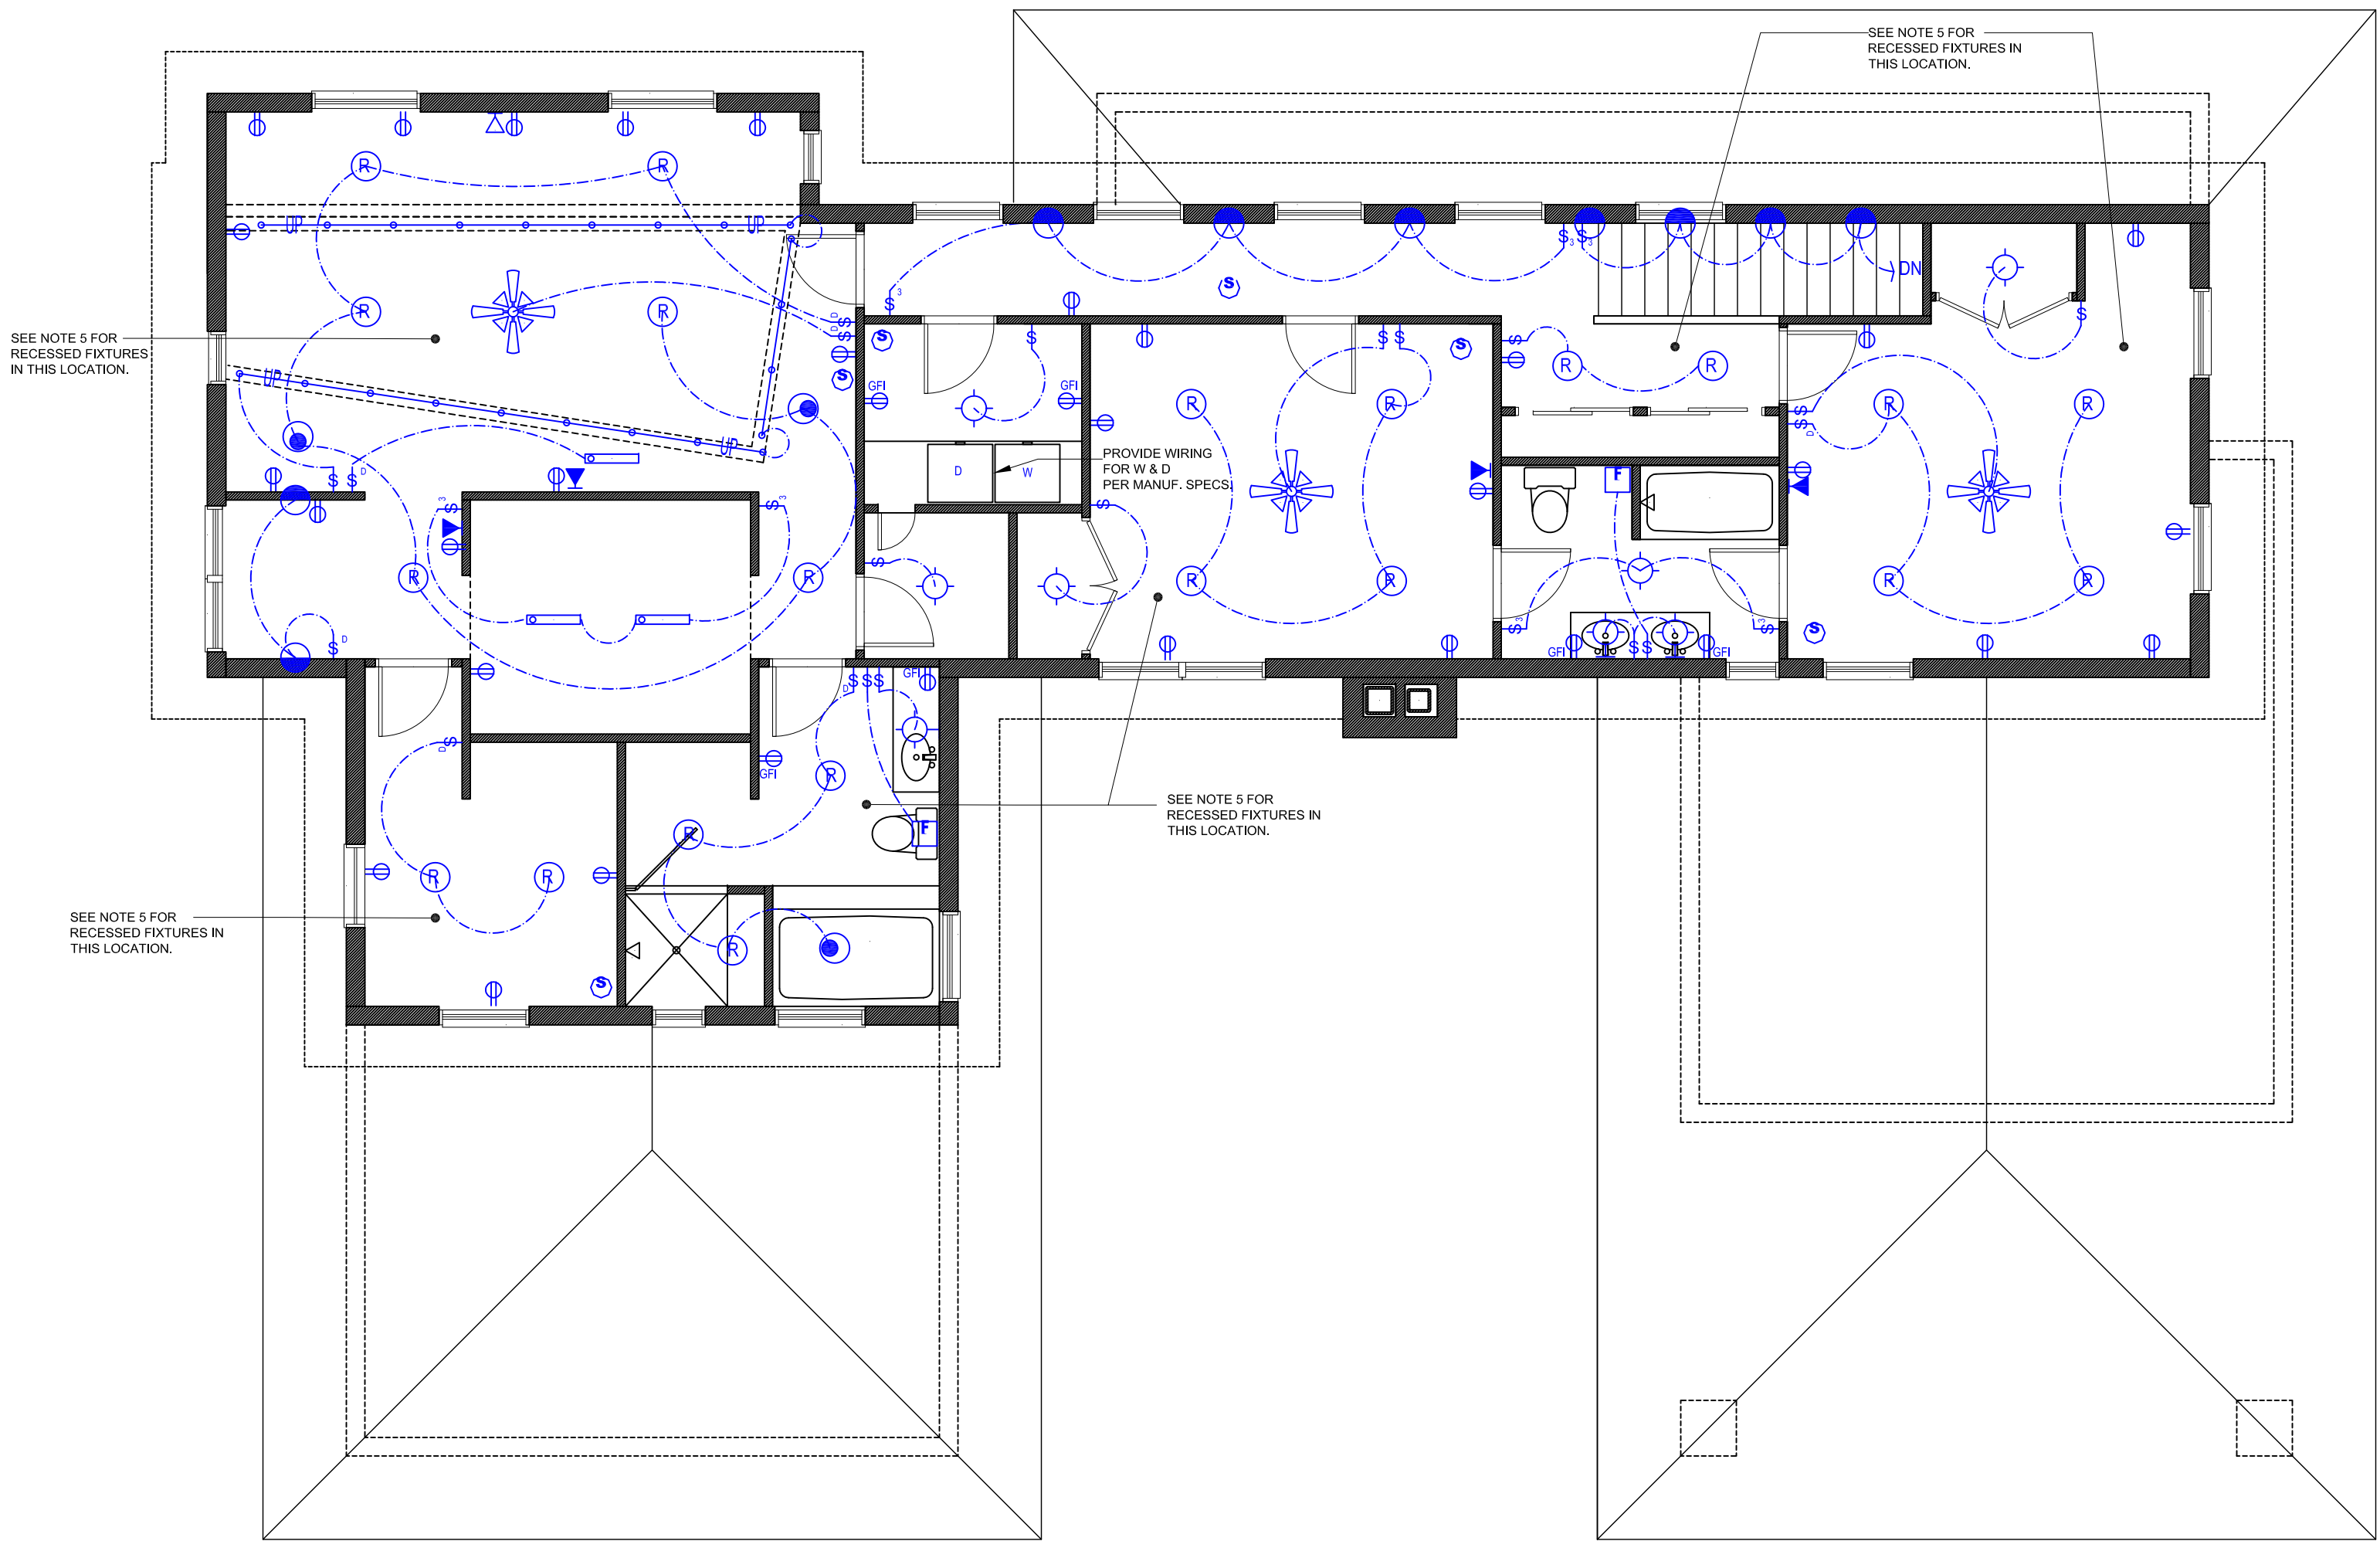
**MOORESTOWN  
RESIDENCE**  
WILLIAMS AVENUE, MOORSETOWN, NEW JERSEY

PROJECT TITLE:

SHEET TITLE: ELECTRICAL PLAN MAIN LEVEL

AS NOTED	JES/MH
SCALE:	DRAWN BY:
4.28.10	JES
DATE:	CHECKED BY:
FILE:	SHEET NUMBER:

E1.2



1 ELECTRICAL PLAN UPPER LEVEL  
E1.2 SCALE: 1/8" = 1'-0"

ELECTRICAL SYMBOLS

- |                                |                                              |                               |                                 |
|--------------------------------|----------------------------------------------|-------------------------------|---------------------------------|
| S SINGLE POLE SWITCH           | ⏏ DUPLEX OUTLET W/ TOP OUTLET SWITCHED       | ⦿ RECESSED DOWNLIGHT          | ☀ FLOOD LIGHT                   |
| ⏏ SINGLE POLE SWITCH W/ DIMMER | ⏏ GFI GROUND FAULT INTERRUPTED DUPLEX OUTLET | ⦿ RECESSED WALL WASH          | ⦿ PATH LIGHTING                 |
| ⏏ THREE POLE SWITCH            | ⦿ WP WATERPROOF / OUTDOOR OUTLET             | ⦿ RECESSED DIRECTIONAL        | ⦿ LED STRIP LIGHT               |
| ⏏ JAMB SWITCH                  | ⦿ FLOOR DUPLEX OUTLET W/ COVER PLATE         | ⦿ SURFACE MOUNTED             | ⦿ LED COVE UPLIGHT              |
| ⏏ SWITCH W/ PILOT LIGHT        | ⦿ QUADPLEX OUTLET                            | ⦿ WALL MOUNTED                | ⦿ FLORESCENT 4' SHOP LIGHT      |
| ⏏ GARGAGE DOOR OPENER          | ⦿ SPECIAL OUTLET                             | ⦿ SURFACE MOUNTED TRACK LIGHT | ⦿ EXHAUST FAN ON TIMER          |
| ⏏ PULL CHAIN                   | ⦿ COVERED JUNCTION BOX                       | ⦿ RECESSED STRIP LIGHT        | ⦿ EXHAUST FAN ON TIMER W/ LIGHT |
| ⏏ TELEPHONE OUTLET             | ⦿ RECESSED AUDIO SPEAKER                     | ⦿ CEILING FAN                 | ⦿ THERMOSTAT                    |
| ⏏ CABLE TELEVISION OUTLET      | ⦿ AUDIO HUB / POWER SOURCE                   | ⦿ CEILING FAN W/ LIGHT        | ⦿ SMOKE DETECTOR (HARDWIRED)    |
| ⏏ DUPLEX OUTLET                | ⦿ MOTORIZED SHADING CONTROLS                 |                               | ⦿ CARBON MONOXIDE DETECTOR      |
| ⏏ DUPLEX OUTLET @ 42" A.F.F.   | ⦿ MOTORIZED SHADES                           |                               | ⦿ HOUSE VACUUM PORT             |

GENERAL NOTES

1. ALL CONDUIT TO BE ARMORED CABLE, TYP.
2. CONDUIT TO BE RUN IN SIP WALLS PER MANUFACTURERS SPECIFICATIONS.
3. PROVIDE WIRING AND VOLTAGE REQUIREMENTS FOR ALL APPLIANCES AND MOTORIZED SHADING DEVICES PER MANUFACTURERS SPECIFICATIONS.
4. ALL RECEPTACLES TO BE 20 AMP CAPACITY
5. ALL RECESS LIGHTING IN ATTIC OR OTHER INSULATED SPACES TO BE THERMALLY RATED & RATED FOR PROXIMITY TO COMBUSTIBLE MATERIALS.
6. ALL EXTERIOR LIGHTING TO BE RATED FOR OUTDOOR USE.
7. OWNER TO PROVIDE DIMENSIONAL LAYOUT OF LIGHTS AND FIXTURES PRIOR TO INSTALLATION OF WORK.
8. OWNER TO PROVIDE SPEC SHEETS FOR ALL APPLIANCES, HARDWARE, LIGHTS, AND FIXTURES PRIOR TO INSTALLATION OF WORK.

ISSUE

NO.	DATE	REMARKS
1.	5.7.10	PERMIT SET / BID SET

SYMBOLS KEY

WORK POINT	⦿
BUILDING SECTION MARKER	⦿
DETAIL SECTION MARKER	⦿
DETAIL MARKER	⦿
BUILDING ELEVATION MARKER	⦿
INTERIOR ELEVATION MARKER	⦿
NORTH ARROW	⦿

I PERSONALLY PREPARED THE PLANS SUBMITTED FOR THIS SINGLE FAMILY DWELLING TO BE OWNED AND OCCUPIED BY MYSELF.

OWNER SIGNATURE: \_\_\_\_\_

MOORESTOWN  
RESIDENCE

WILLIAMS AVENUE, MOORSETOWN, NEW JERSEY

PROJECT TITLE:

ELECTRICAL PLAN MAIN LEVEL

AS NOTED	JES/MH	E1.3
SCALE:	DRAWN BY:	
4.28.10	JES	
DATE:	CHECKED BY:	
FILE:	SHEET NUMBER:	

CONSTRUCTION DOCUMENT REVIEW SET  
SUBMITTED FOR PERMITTING & PRICING.